


SCALE: 1"=10'

- 1. SIDE YARD SETBACKS SHALL BE 8' TOTAL (4' & 4", OR 5' & 3')
- 2. OVERHANGS SHALL NOT EXTEND INTO THE 4' PUE. 3. OVERHANGS SHALL NOT EXTEND INTO 3' SIDEYARD SETBACK MORE THAN 1',
- ON ALL PLANS.
- 4. PARKING IS PROHIBITED IN DRIVEWAY WHERE LESS THAN 18' DEEP (TYP.)

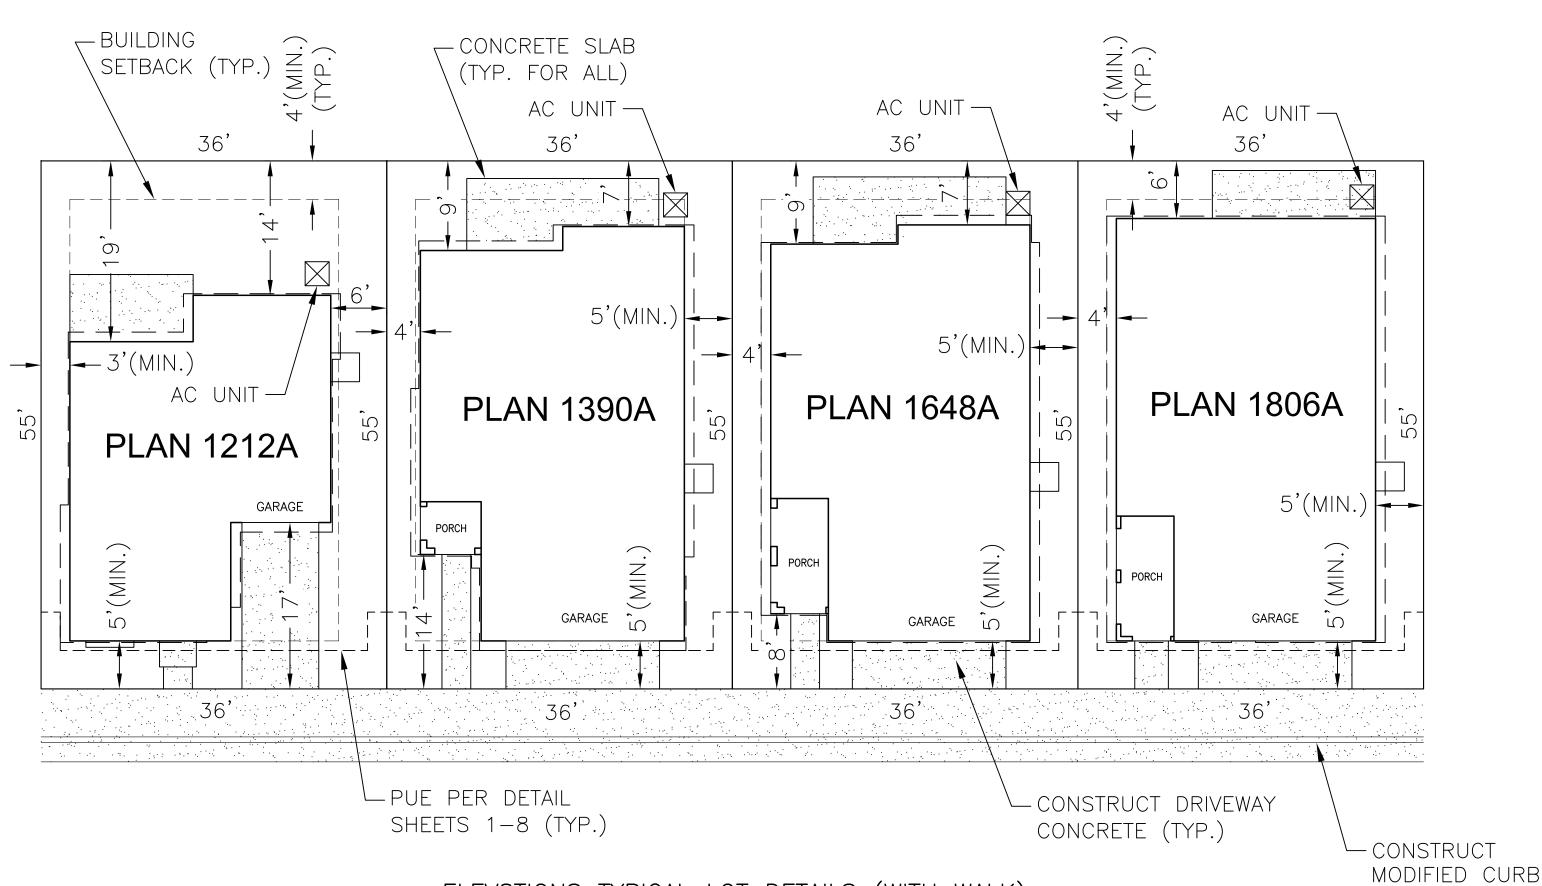

ELEV8TIONS TYPICAL LOT DETAILS (WITH WALK)

SCALE: 1"=10'

- 1. SIDE YARD SETBACKS SHALL BE 8' TOTAL (4' & 4", OR 5' & 3')
- 2. OVERHANGS SHALL NOT EXTEND INTO THE 4' PUE.

NOTES:

- 3. OVERHANGS SHALL NOT EXTEND INTO 3' SIDEYARD SETBACK MORE THAN 1', ON ALL PLANS.
- 4. PARKING IS PROHIBITED IN DRIVEWAY WHERE LESS THAN 18' DEEP (TYP.)

NOTES

- 1. REPAIR ALL DAMAGED AND/OR OFF-GRADE CONCRETE STREET IMPROVEMENTS AS DETERMINED BY THE CONSTRUCTION MANAGEMENT ENGINEER PRIOR TO OCCUPANCY.
- 2. ALL SURVEY MONUMENTS WITHIN THE AREA OF CONSTRUCTION SHALL BE PRESERVED AND IF DISTURBED, SHALL BE RESET BY A PERSON LICENSED TO PRACTICE LAND SURVEYING IN THE STATE
- 3. TWO (2) WORKING DAYS BEFORE COMMENCING EXCAVATION OPERATION WITHIN THE STREET RIGHT-OF-WAY AND/OR UTILITY EASEMENTS, ALL EXISTING UNDERGROUND FACILITIES SHALL HAVE BEEN LOCATED BY UNDERGROUND SERVICE ALERT (USA). CALL 1-800-642-2444.
- 4. THE RELOCATION OF ANY UTILITIES TO THE DESIGN ALIGNMENT AND GRADE SHALL BE THE RESPONSIBILITY AND AT THE EXPENSE OF THE DEVELOPER. CONTACT TRAFFIC ENGINEER FOR INFORMATION REGARDING REIMBURSEMENT RELATIVE TO RELOCATING TRAFFIC SIGNAL FACILITIES.
- 5. APPROVAL OF THIS SPECIAL PERMIT MAY BECOME NULL AND VOID IN THE EVENT THAT DEVELOPMENT IS NOT COMPLETED IN ACCORDANCE WITH ALL THE CONDITIONS AND REQUIREMENTS IMPOSED ON THIS SPECIAL PERMIT, THE ZONING ORDINANCE, AND ALL PUBLIC WORKS STANDARDS AND SPECIFICATIONS. THE PLANNING AND DEVELOPMENT DEPARTMENT SHALL NOT ASSUME RESPONSIBILITY FOR ANY DELETIONS OR OMISSIONS RESULTING FROM THE SPECIAL PERMIT REVIEW PROCESS OR FOR ADDITIONS OR ALTERATIONS TO CONSTRUCTION PLAN NOT SPECIFICALLY SUBMITTED AND REVIEWED AND APPROVED PURSUANT TO THIS SPECIAL PERMIT OR SUBSEQUENT AMENDMENTS OR REVISIONS.
- 6. NO USES OF LAND, BUILDINGS, OR STRUCTURES OTHER THAN THOSE SPECIFICALLY APPROVED PURSUANT TO THIS SITE PLAN SHALL BE PERMITTED.
- 7. ALL TREES SHALL BE MAINTAINED IN GOOD HEALTH. TREES MAY NOT BE TRIMMED OR PRUNED TO REDUCE THE NATURAL HEIGHT OR OVERALL CROWN OF THE TREE, EXCEPT AS NECESSARY FOR THE HEALTH OF THE TREE AND PUBLIC SAFETY; OR AS MAY OTHERWISE BE APPROVED BY THE PLANNING AND DEVELOPMENT DEPARTMENT.
- 8. A HOLD ON OCCUPANCY SHALL BE PLACED ON THE PROPOSED DEVELOPMENT UNTIL SUCH TIME THAT LANDSCAPING HAS BEEN APPROVED AND VERIFIED FOR PROPER INSTALLATION BY THE PLANNING
- 9. PRIOR TO GRANTING OF FINAL OCCUPANCY, A WRITTEN CERTIFICATION, SIGNED BY A LANDSCAPE PROFESSIONAL APPROVED BY THE DEVELOPMENT AND RESOURCE MANAGEMENT DEPARTMENT DIRECTOR, SHALL BE SUBMITTED STATING THAT THE REQUIRED LANDSCAPING AND IRRIGATION SYSTEMS HAVE BEEN INSTALLED IN ACCORDANCE WITH THE LANDSCAPING AND IRRIGATION PLANS APPROVED BY THE
- 10. ALL PROPOSED FENCES, HEDGES AND WALLS, ETC. SHALL BE REVIEWED AND APPROVED PRIOR TO INSTALLATION BY THE CITY OF FRESNO, DEVELOPMENT AND RESOURCE MANAGEMENT DEPARTMENT.
- 11. SIGNS, OTHER THAN DIRECTIONAL SIGNS, IF APPLICABLE, ARE NOT APPROVED FOR INSTALLATION AS PART OF THIS SPECIAL PERMIT. SUBMIT FOR A SEPARATE MASTER SIGN PROGRAM OR SIGN REVIEW APPLICATION. APPLICATIONS AND REQUIREMENT FOR SUBMITTAL ARE AVAILABLE AT THE PLANNING DIVISION'S PUBLIC FRONT COUNTER.
- 12. FIRE HYDRANTS AND ACCESS ROADS SHALL BE INSTALLED, TESTED AND APPROVED AND SHALL BE MAINTAINED SERVICEABLE PRIOR AND DURING ALL PHASES OF DEVELOPMENT.
- 13. ALL CONSTRUCTION WORK ON THIS PROJECT IS SUBJECT TO INTERRUPTION IF THE ROAD SYSTEM BECOMES IMPASSABLE FOR FIRE APPARATUS DUE TO RAIN OR OTHER OBSTACLES. ALL REQUIRED FIRE ACCESS LANES SHALL BE PROVIDED AND MAINTAINED WITH AN APPROVED "ALL WEATHER" SURFACE CAPABLE OF SUPPORTING 80,000 LBS.
- 14. TWO MEANS OF INGRESS/EGRESS MUST BE PROVIDED. THIS ACCESS MUST BE MAINTAINED DURING ALL PHASES OF DEVELOPMENT.
- 15. PROVIDE SIGNS(S) (17"X22" MINIMUM) AT ALL PUBLIC ENTRANCE DRIVES TO THE PROPERTY "WARNING-VEHICLES STOPPED, PARKED OR LEFT STANDING IN FIRE LANES WILL BE IMMEDIATELY REMOVED AT OWNER'S EXPENSE - 22658 CALIFORNIA VEHICLE CODE - FRESNO POLICE DEPARTMENT 621-2300."
- 16. TURNS IN PRIVATE DRIVES FOR FIRE TRUCK ACCESS SHALL HAVE A MINIMUM 44 FOOT CENTERLINE
- 17. ALL GATES ON COMMON ACCESS DRIVES SHALL BE EQUIPPED WITH FIRE X-1 BYPASS HARDWARE IN ADDITION TO APPROVED "CLICK TO ENTER" SYSTEM. SYSTEM. GATES/FENCES SHALL NOT OBSTRUCT
- THE MINIMUM WIDTH REQUIRED FOR FIRE LANES. 18. ELECTRIC GATES SHALL BE PROVIDED WITH BATTERY BACKUP.
- 19. PROVIDE APPROVED VISUAL RECOGNITION FEATURE/SIGN AT THE "CLICK TO ENTER" GATE LOCATIONS. 20. STREET FURNITURE LOCATIONS SHALL BE COORDINATED SO THAT THEY ARE NOT POSITIONED IN THE
- 21. PROVIDE CC&R'S FOR ANNUAL FIRE INSPECTION FEES FOR MAINTENANCE OF ACCESS AND PARKING
- 22. VEHICULAR GATES TO BE OPEN DURING PEAK HOURS FROM 7:00AM TO 9:00AM AND 4:00PM TO
- 23. LOT COVERAGE IS 60% MAX, PER RS-5 ZONING.

OUTSIDE SWEEP OF ANY TURN RADIUS.


FIRE HYDRANT NOTES

- 1. PRIVATE HYDRANTS MUST BE INSTALLED. HYDRANT LOCATIONS SHALL BE COORDINATED SO THAT THEY ARE NOT POSITIONED IN THE OUTSIDE SWEEP OF ANY TURN RADIUS.
- 2. ALL FIRE HYDRANTS SHALL BE PROVIDED WITH APPROVED PROTECTED BOLLARDS OR STANDARD
- 3. FIRE HYDRANTS SHALL BE INSTALLED. TESTED, APPROVED, AND ALL SURFACE ACCESS ROADS SHALL BE INSTALLED AND MADE SERVICEABLE PRIOR TO AND DURING THE TIME OF CONSTRUCTION.
- THE HYDRANT 41" OUTLET SHALL FACE THE ACCESS LANE. 4. FIRE HYDRANTS SHALL BE PUBLIC HYDRANTS. OUTLOT A IS DESIGNATED FOR PUBLIC UTILITY

APPL. NO. P22-00387 EXHIBIT A-9 DATE 3/29/23 PLANNING REVIEW B TRAFFIC ENG. DATE APPROVED BY CITY OF FRESNO DARM DEPT

DETAILS

PLANNED DEVELOPMENT SITE PLAN FOR TRACT 6360 Wilson Premier Homes, Inc. 7550 NORTH PALM AVENUE SUITE 102 FRESNO, CA. 93711 559-224-7550 REVISIONS SHEET NO Harbour & Associates
Civil Engineers
389 Clovis Avenue, Suite 300
(559) 325 - 7676 • Fax (559) 325 389 Clovis Avenue, Suite 300 • Clovis, California 93612 OF DATE: 3-29-23 SCALE: 1"=10'

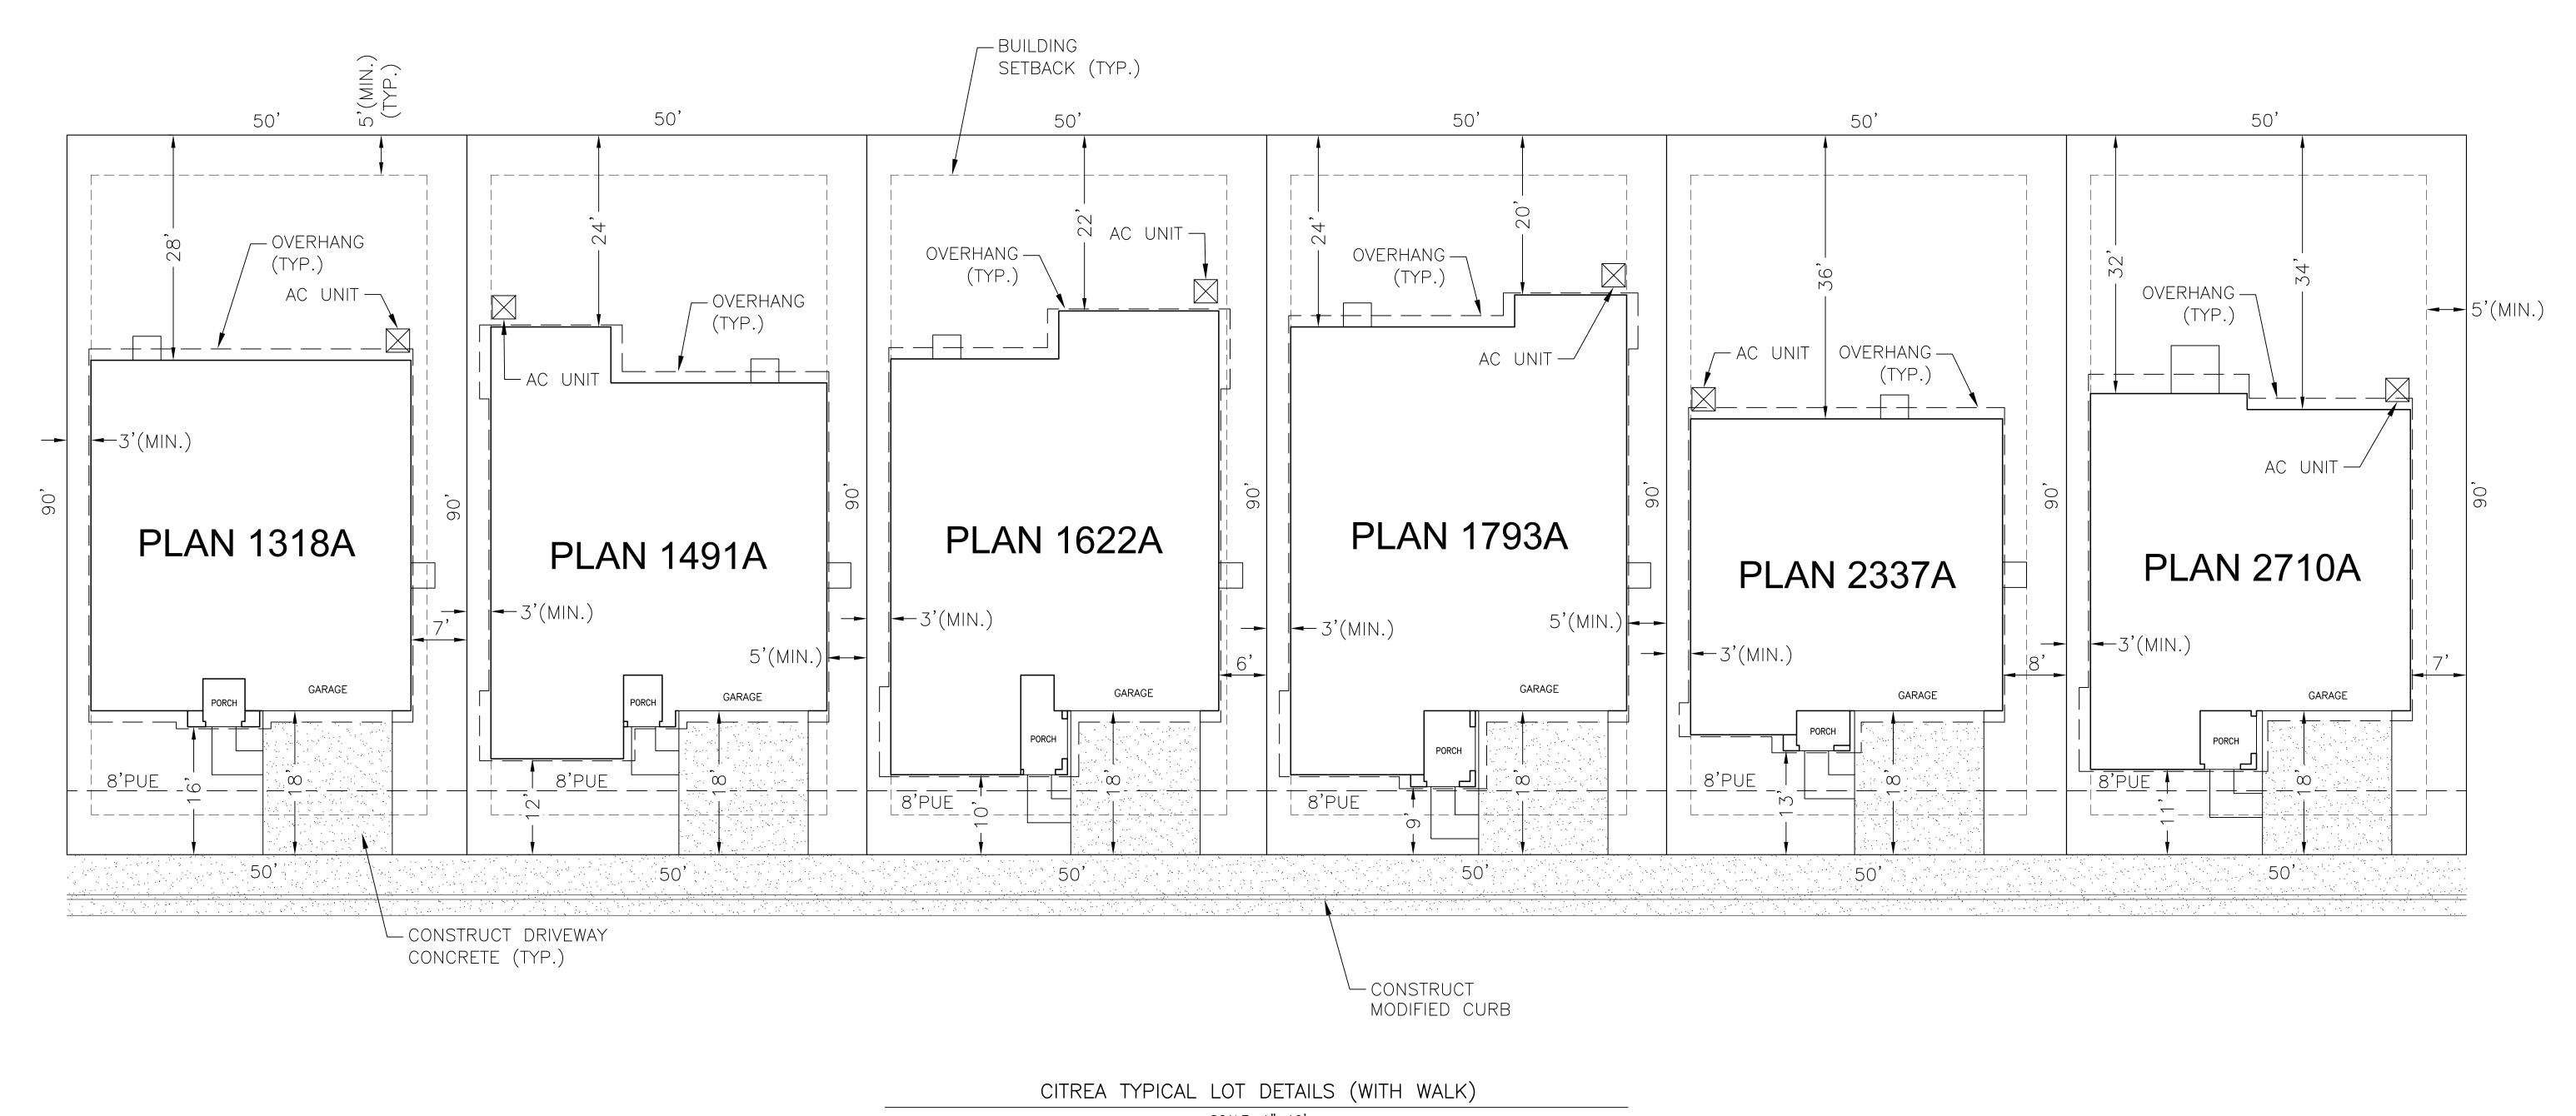

SCALE: 1"=10'

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APPL. NO. P22-00387 EXHIBIT A-10 DATE 3/29/23
PLANNING REVIEW BY ______ DATE_____
TRAFFIC ENG. ______ DATE____
APPROVED BY ______ DATE_____
CITY OF FRESNO DARM DEPT

DETAILS

PLANNED DEVELOPMENT SITE PLAN FOR TRACT 6360

SUBDIVIDER

Wilson Premier Homes, Inc.

7550 NORTH PALM AVENUE SUITE 102
FRESNO, CA. 93711
559-224-7550

Harbour & Associates

Civil Engineers
389 Clovis Avenue, Suite 300 • Clovis, California 93612
(559) 325-7676 • Fax (559) 325-7699 • e-mail lorrens@harbour-engineering.com

DATE: 3-29-23

SCALE: 1"=10'

DRAWN BY: SDH

SHEET NO.

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Y: SDH