

TOWER DISTRICT DESIGN REVIEW COMMITTEE MEETING AGENDA

Tuesday May 7, 2024 – 5:00 p.m.

THIS MEETING WILL OCCUR IN PERSON AND ELECTRONIC. To participate in person: CITY HALL (2600 FRESNO ST, FRESNO, CA 93721), ROOM 2165.

To participate electronically via Zoom: ZOOM MEETING & PHONE INSTRUCTIONS

Click here to register and join meeting:

Join by phone: +1 669 900 9128

* To view exhibits, please visit https://fresno.legistar.com/calendar.aspx, select "Tower District Design Review Committee" in the dropdown menu, then click "Meeting Details" for the applicable meeting date.

I. CALL TO ORDER & ROLL CALL

This meeting was called to order at 5:00 p.m. with a master roll call.

Present – 4: Daniel Renteria, Michael Clifton, Tom Key, Robert Hernandez

Absent – 1: Jasjit Kamboj

Staff: Luke Risner

II. APPROVAL OF AGENDA

Committee member Clifton moved and Committee member Key seconded the motion to approve the agenda for May 7, 2024. The motion carried four votes to zero.

III. APPROVAL OF THE MINUTES

Committee member Key moved and Committee member Clifton seconded the motion to approve the minutes from the April 2, 2024 meeting. The motion carried four votes to zero.

IV. CONTINUED MATTERS

None.

V. PROJECT REVIEW

These items will be reviewed by the Committee and may be subject to a vote of the Committee. Applicants and/or their representatives are asked to be in attendance to discuss these projects.

A. Root Access Hackerspace Signage

Location: 1476 N Van Ness Ave

TOWER DISTRICT DESIGN REVIEW COMMITTEE MEETING AGENDA

Tuesday May 7, 2024 – 5:00 p.m.

Applicant: Derek Payton

New signage for Root Access Hackerspace.

Staff gave a brief presentation on the proposed signage improvements in the absence of the project applicant.

Committee member Key moved to recommend approval of the proposed signage, and Committee member Clifton seconded the motion.

Vote Tally

Ayes (4): Key (motion), Clifton (second), Renteria, Hernandez

Noes (0): None Abstain (0): None Absent (1): Kamboj

B. Solar Cantilevered Carport

Location: 1369 N San Pablo Ave Applicant: De Alba Architecture

New solar carport cantilevered off the side of the existing single-family residence located at 1369 N San Pablo Ave.

Staff gave a brief presentation on the proposed signage improvements in the absence of the project applicant.

Committee member Clifton moved to not recommend approval of the proposed solar cantilevered carport, and Committee member Key seconded the motion.

Vote Tally

Ayes (0): None

Noes (4): Clifton (motion), Key (second), Renteria, Hernandez

Abstain (0): None Absent (2): Kamboj

C. Repeat Performance Signage

Location: 1429 N Van Ness Ave

Applicant: Gwynn Clark

New signage for Repeat Performance

Staff gave a brief presentation on the proposed signage improvements in the absence of the project applicant.

TOWER DISTRICT DESIGN REVIEW COMMITTEE MEETING AGENDA Tuesday May 7, 2024 – 5:00 p.m.

Committee member Key moved to recommend approval of the proposed solar cantilevered carport, and Committee member Renteria seconded the motion.

Vote Tally

Ayes (4): Key (motion), Renteria (second), Clifton, Hernandez

Noes (0): None Abstain (0): None Absent (1): Kamboj

VI. UNSCHEDULED COMMUNICATIONS

None.


VII. ADJOURNMENT

The Committee, having concluded all business, adjourned at 5:42 p.m.

Respectfully,

Valeria Ramirez

Valeria Ramirez Committee Staff Liaison

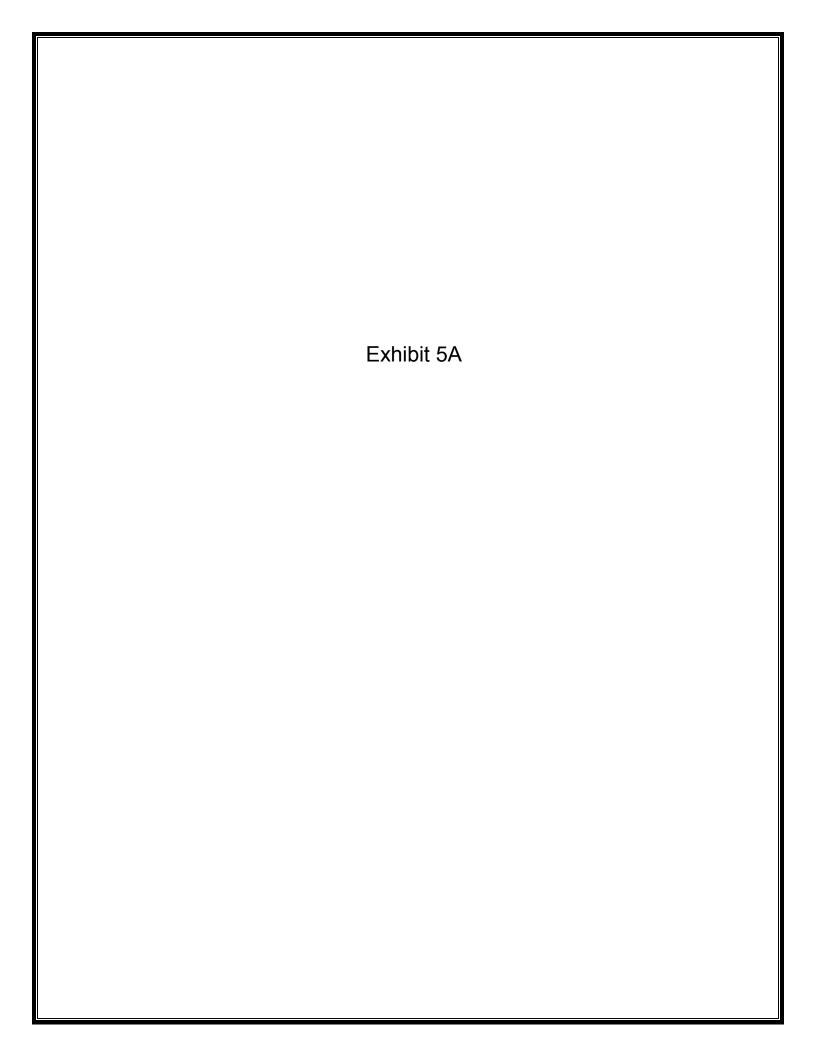

LEAP RESIDENCE ADDITION & REMODEL

815 N. ADOLINE, FRESNO CA 93728

KEYNOTE

ROOM NAME

- AREA (SQ FT)

MODIFICATION NOTE

CABINET HEIGHT

— CABINET WIDTH

WDHT DP CABINET DEPTH

DISCIPLINE

G GENERAL

L LANDSCAPE

Q EQUIPMENT

P PLUMBING

S STRUCTURAL

M MECHANICAL

E ELECTRICAL

FA FIRE ALARM

AV AV EQUIPMENT

FP FIRE PROTECTION

T TELECOM

K KITCHEN

SHEET TYPE

(IF APPLICABLE)

A ARCHITECTURE

INTERIORS

C CIVIL

ROOM NAME

- ROOM NUMBER

- OCCUPANT LOAD

DEMO KEYNOTE NUMBER

(SEE LEGEND ON SHEET)

(SEE LEGEND ON SHEET)

OCCUPANT LOAD FACTOR

(REFER TO TABLE 1004.1.1)

- NUMBER OF EXITS REQUIRED

WIC CASEWORK TAG

- MANUFACTURER REFERNCE AND MODEL NUMBER

SHEET TYPE

1 SITE PLAN

2 FLOOR PLAN

5 ELEVATIONS

6 SECTIONS

9 SCHEDULES

10 DETAILS

8 MISC.

FLOOR LEVEL

4 FRAMING PLANS

ENLARGED PLANS

(USER DEFINED)

USED ONLY IF REQUIRED.

IF NOT, COLUMN IS OMITTED.

0 CODE ANALYSIS, NOTES

3 CEILING PLAN &/OR ROOF PLAN

BUILDING LETTER/SEGMENT

(IF APPLICABLE)

(REFER TO TABLE 1015.1)

(AREA DIVIDED BY LOAD FACTOR)

- NEW WORK KEYNOTE NUMBER

ROOM EXITING INFORMATION

ANGLE

ACT

ALT

ALUM

ANSI

ARCH

BLDG

BLKG

CAB

CBC

CANT

CEM

CER

CFOI

CHKD

CLR

CONC

CONF

COORD

CORR

DEMO

DEPT

DIM

DWG

ELEC

ELEV

EQUIP

FEC

FOC

FOS

GYP BD

DIR

APPROX

ADMIN

ANCHOR BOLT

AIR CONDITIONING

ADMINISTRATION

ALTERNATE

APPROXIMATE

ARCHITECTURAL

AUDIO / VISUAL

ALUMINUM

BUILDING

BLOCKING

CHANNEL

CABINET

CEMENT

CERAMIC

CHECKED

CAST IRON

CONCRETE

CORRIDOR

CONFERENCE

DEPARTMENT

DIMENSION

DRAWING

EXISTING

ELECTRICAL

ELEVATION

EQUIPMENT

FACE OF

FOOT or FEET

FIRE EXTINGUISHER

FLOOR or FLOORING

FACE OF CONCRETE

FACE OF FINISH

FACE OF STUD

GYPSUM BOARD

FIRE RATED

FIRE EXTINGUISHER & CABINET

INDUSTRY. CONTACT DRAFTER FOR NECESSARY CLARIFICATION.

DRINKING FOUNTAIN

CEILING

CLEAR

DIA OR Ø DIAMETER

CONTROL JOINT

CENTER LINE

CANTILEVER

CUBIC FOOT or FEET

OWNER INSTALLED

CORNER GUARD

ASPHALTIC CONCRETE

ABOVE FINISHED FLOOR

ACOUSTICAL or ACOUSTIC

CALIFORNIA BUILDING CODE

CONTRACTOR FURNISHED

COORDINATE or COORDINATOR

DEMOLISH or DEMOLITION

DIRECTOR or DIRECTORY

AMERICAN NATIONAL STANDARDS INST.

OVERLAY ARROW INDICATES TRUE NORTH

SHADED AREA INDICATES PLAN NORTH

ELEVATION CALLOUT

LOCATION ON SHEET

AXX.XX.XX LOCATION ON SHEET

SECTION CALLOUT

DETAIL CALLOUT

__FIRST FLOOR_•__ NAME OF ELEVATION (IF APPLICABLE)

- GRID NUMBER

AXX.XX.XX

≠ +0' - 0"•<

(A101•)

AA •

<E-S8A-1•<

- INDICATES A SIMILAR CONDITION

SHEET WHERE SECTION IS DRAWN

- INDICATES A SIMILAR CONDITION

SHEET WHERE SECTION IS DRAWN

— INDICATES A SIMILAR CONDITION

— SHEET WHERE SECTION IS DRAWN

CONTROL OR DATUM POINT

- ELEVATION ABOVE FINISHED FLOOR

EXISTING BUILDING GRID SYMBOL

INTERIOR FINISH CALLOUT

EQUIPMENT TYPE CALLOUT

- REFER TO EQUIPMENT SCHEDULE

REFER TO WALL TYPE SCHEDULE

WALL TYPE CALLOUT


NEW BUILDING GRID SYMBOL

DOOR CALLOUT

- MATERIAL FINISH TYPE

WINDOW CALLOUT

WINDOW NUMBER

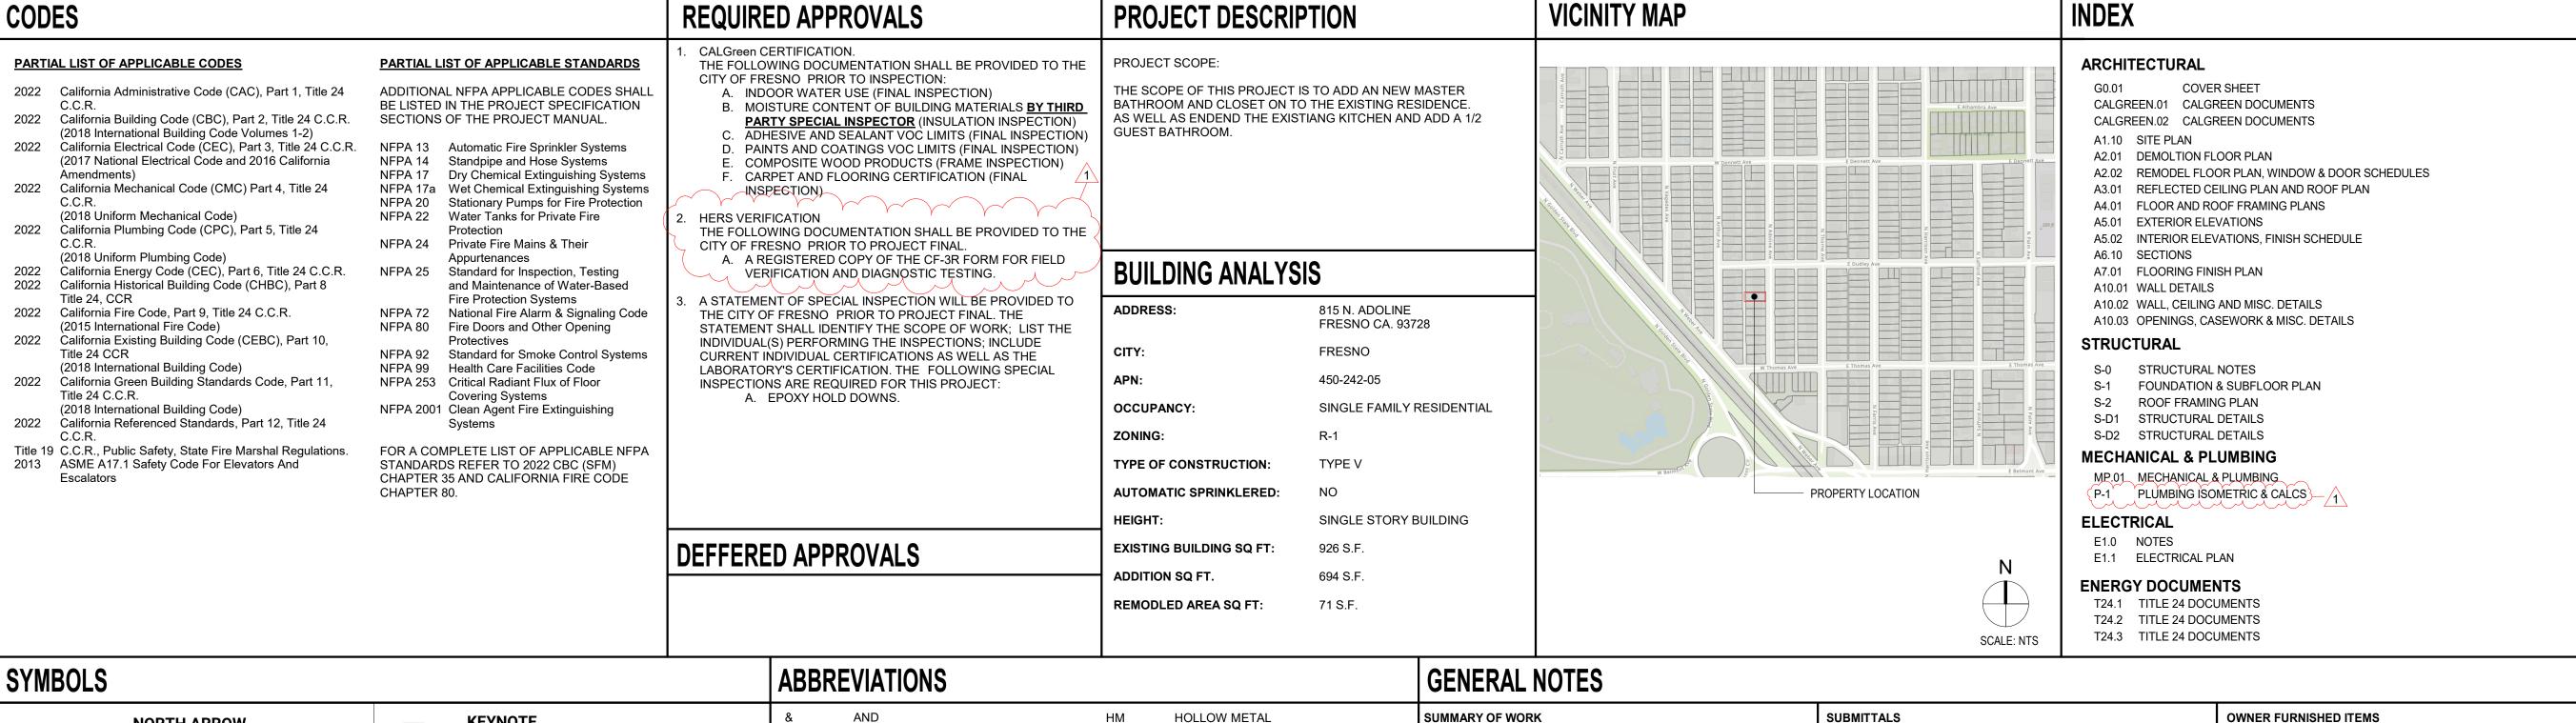

INSIDE DIAMETER

INTERNATIONAL CODE COUNSEL

INCH or INCHES

JANITORIAL

KITCHEN

LAVATORY

LEAD LINED

MECHANICAL

MISCELLANEOUS

NOT APPLICABLE

NOT TO SCALE

PENNY (nail size)

PLUS OR MINUS

NOT IN CONTRACT

OUTSIDE DIAMETER

PERPENDICULAR

PLASTIC LAMINATE

RADIUS (IN NOTES)

RECEPTIONIST

SCHEDULE

SIMILAR

STORAGE

STRUCTURAL

SUSPENDED

TOP OF DRAIN

TOP OF PARAPET

TOP OF ROOF OR RIDGE

VENDOR FURNISHED

VENDOR INSTALLED

VERIFY IN FIELD

WATER HEATER

OWNER FURNISHED

OWNER INSTALLED

WOOD SCREW

WOOD

UNLESS NOTED OTHERWISE

TOP OF PLATE

OP OF SLAB

TOP OF WALL

TOP OF STEEL

REFRIGERATOR

PREPARATION or PREPARE

RADIUS (IN DIMENSIONS)

SQUARE FOOT OR FEET

SHEET METAL SCREWS

STAINLESS STEEL

TOP OF CONCRETE

TOP OF FRAMING OR TOP OF FOOTING

MAXIMUM

MINIMUM

MOUNTED

METAL

POUND

PLUMBING

PLYWOOD

" OR IN

ICC

KIT

LAV

PLUMB

PLYWD

SCHED

STOR

TOF

TOPL

TOW

TST

OTHER ABBREVIATIONS USED ON THESE DRAWINGS ARE CONSIDERED STANDARDS IN THE BUILDING

STRUCT

1049 E. Manhattan Ave. / Fresno, CA 93720 Hillary Rodrigue: 559.476.6806 • Hillary.drafting@gmail.com

PROJECT

LEAP RESIDENCE ADDITION AND REMODEL

815 N. ADOLINE AVE. FRESNO. CA 93728

LYELL & MELISSA LEAP

815 N. ADOLINE AVE. / FRESNO, CA 93728 559.770.7082

Project Number: 1001001

Revisions Issued:

PLANCHECK #001

12.07.2023

ARCHITECTURAL DRAFTING & DESIGNER HILLARY B. RODRIGUEZ

1049 E. MANHATTAN AVE. / FRESNO, CA 93720 559.473.6806

STRUCTURAL

KYLE M. POPE

1250 SUNNYSIDE AVE. SUITE 105 / CLOVIS, CA 93611 (559) 385-5110

ELECTRICAL

VALLEY UNIQUE ELECTRIC, INC. 75 PARK CREEK DR. / CLOVIS, CA 93611

(559) 277-2000

Agency Approval:

Sheet Title:

COVER SHEET

Sheet Number:

SUMMARY OF WORK ARCHITECTURAL DRAWINGS TAKE PRECEDENCE OVER OTHER DRAWINGS. THE ELECTRICAL, MECHANICAL, AND OTHER DRAWINGS ARE SUPPLEMENTARY TO THE ARCHITECTURAL DRAWINGS. DRAWING DIVISIONS ARE NOT INTENDED TO DIVIDE THE CONSTRUCTION WORK BY TRADE

OR CONTRACT. CONTRACTOR WILL COORDINATE ALL WORK WITH THE ARCHITECTURAL DRAWINGS BEFORE PROCEEDING WITH THE WORK. NOTIFY THE ARCHITECT FOR CLARIFICATION OF DISCOVERED DISCREPANCIES. WORK INSTALLED IN CONFLICT WITH THE ARCHITECTURAL DRAWINGS SHALL BE CORRECTED BY THE CONTRACTOR AT NO ADDITIONAL COST TO THE OWNER.

THE SPECIFICATIONS ARE AN INTEGRAL PART OF THE CONTRACT DOCUMENTS. FOR SPECIFIC REQUIREMENTS O MATERIAL, WORKMANSHIP, AND PERFORMANCE, REFER TO SPECIFICATIONS AND GENERAL REQUIREMENTS.

ALL DIMENSIONS ARE TO "FACE OF STUD" OR FROM "GRID LINES" IN NEW CONSTRUCTION AND "FACE OF FINISH" IN EXISTING CONDITION, UNO.

WRITTEN DIMENSIONS ON DRAWINGS TAKE PRECEDENCE OVER SCALED DIMENSIONS. DO NOT SCALE DRAWINGS TO DETERMINE THE FINAL WORKING DIMENSIONS. DISCREPANCIES SHALL BE REPORTED TO THE ARCHITECT BEFORE PROCEEDING WITH WORK

HEIGHTS ARE DIMENSIONED FROM "ABOVE FINISH FLOOR" **UNLESS NOTED OTHERWISE** IN THE EVENT THAT CERTAIN FEATURES OF THE WORK ARE NOT FULLY SHOWN OR DETAILED ON THE DRAWINGS OR CALLED FOR IN THE GENERAL NOTES, THEIR

CONSTRUCTION SHALL BE OF THE SAME CHARACTER AS SIMILAR CONDITIONS THAT ARE SHOWN. ITEMS NOT IDENTIFIED AS "EXISTING" ARE INTENDED AS NEW AND TO BE PROVIDED AS PART OF THIS PROJECT. "TYPICAL" SHALL MEAN IDENTICAL FOR ALL SAME CONDITIONS. "SIMILAR" SHALL MEAN COMPARABLE CHARACTERISTICS FOR THE CONDITIONS NOTED

CONTRACTORS MANAGEMENT & COORDINATION

THE GENERAL CONTRACTOR WILL BE REQUIRED TO ATTEND ANY PROJECT CONSTRUCTION MEETINGS THAT ARE SCHEDULED THROUGHOUT THE COURSE OF THE PROJECT. HE/SHE WILL PROVIDE AND DISTRIBUTE MEETING NOTES TO ALL PARTIES INVOLVED.

CONTRACTOR IS RESPONSIBLE FOR COORDINATING THE CONTRACT DOCUMENTS, FIELD CONDITIONS AND DIMENSIONS, FOR ACCURACY AND CONFIRMING THAT WORK IS CONSTRUCTIBLE AS SHOWN PRIOR TO PROCEEDING WITH THE WORK. FOR QUESTIONS REGARDING THE CONTRACT DOCUMENTS OR OTHER COORDINATION QUESTIONS, OBTAIN WRITTEN CLARIFICATION FROM THE ARCHITECT PRIOR TO

PROCEEDING WITH WORK. CONTRACTOR SHALL INFORM THE ARCHITECT OF CONFLICTS THAT EXIST IN LOCATIONS OF MECHANICAL COMMUNICATION, ELECTRICAL, LIGHTING, PLUMBING, AND FIRE SPRINKLER EQUIPMENT. CONFIRM REQUIRED CLEARANCES FOR INSTALLATION AND MAINTENANCE OF EQUIPMENT IS PROVIDED.

CONTRACTOR SHALL BE RESPONSIBLE FOR CUTTING FITTING, AND PATCHING THAT MAY BE REQUIRED TO COMPLETE THE WORK, OR TO MAKE ITS MANY PARTS FIT TOGETHER PROPERLY. PROTECT ADJACENT CONSTRUCTION FROM DAMAGE. CUTTING AND WEAKENING OF EXISTING STRUCTURAL COMPONENTS. WALLS, FLOORS, AND ROOF MEMBERS IS PROHIBITED UNLESS FULLY DETAILED ON THE PLANS.

SUBMITTALS |

ALL CHEMICAL OR HAZARDOUS PRODUCTS SHALL HAVE A MATERIAL SAFETY DATA SHEET (MSDS) AND BE LOCATED ON SITE. ALL PRODUCTS MUST BE SUBMITTED TO THE OWNER'S REPRESENTATIVE (ARCHITECT) FOR APPROVAL APPROVED PRODUCT SPECIFICATION SHEETS CONTRACTOR SHALL CERTIFY THAT NO ASBESTOS CONTAINING MATERIAL (ACM) IS USED ON THE PROJECT.

ANY EQUIPMENT ARRIVING ON SITE DAMAGED OR SUBSEQUENTLY DAMAGED ON SITE, SHALL BE REPLACED WITH NEW EQUIPMENT AS DIRECTED BY THE OWNER'S REPRESENTATIVE (ARCHITECT).

ALTERATION PROJECT PROCEDURES

EXISTING CONSTRUCTION DATA SHOWN ON THE DRAWINGS WAS OBTAINED FROM AVAILABLE OWNER PROVIDED DRAWINGS. INFORMATION SHOWN ON THE DRAWINGS RELATIVE TO EXISTING CONDITIONS IS PROVIDED AS THE "BEST PRESENT KNOWLEDGE", BUT WITHOUT GUARANTEE OF ACCURACY. DIMENSIONS, ELEVATIONS, AND EXISTING CONDITIONS SHALL BE FIELD VERIFIED ON THE JOB SITE, DISCREPANCIES SHALL BE REPORTED TO THE ARCHITECT BEFORE PROCEEDING WITH WORK.

ITEMS IDENTIFIED TO BE DEMOLISHED, REMOVED, OR RELOCATED ARE TO BE COMPLETELY REMOVED. INCLUDING, BUT NOT LIMITED TO CONCEALED ITEMS (PIPES, CURBS, FRAMING, FASTENERS, ETC.). ITEMS WITHIN A DEMOLITION AREA THAT MUST BE REROUTED IN ORDER TO MAINTAIN CONTINUITY SHALL BE DONE SO IN ACCORDANCE WITH THE APPROPRIATE SPECIFICATION SECTIONS, AT NO ADDITIONAL COST TO THE OWNER. CONTINUITY SHALL BE MAINTAINED BY CURRENT STANDARD CONSTRUCTION METHODS, EQUAL TO OR GREATER THAN THE QUALITY OF THE EXISTING CONDITION. ANY AREA OF DEMOLITION SHALL BE LEFT IN A COMPLETE AND CLEAN CONDITION, READY FOR NEW WORK, AS

REGULATORY REQUIREMENTS

CONTRACTOR IS RESPONSIBLE FOR PROVIDING WORK AND MATERIALS IN STRICT COMPLIANCE WITH LOCAL, COUNTY, STATE, AND FEDERAL REGULATORY AGENCIES AND APPLICABLE BUILDING CODES.

OUTLINED IN THE DOCUMENTS AND DRAWINGS.

THE INTENT OF THE CONSTRUCTION DOCUMENTS IS TO RECONSTRUCT THE HOSPITAL BUILDING IN ACCORDANCE WITH THE 2019 CBC. SHOULD ANY CONDITION DEVELOP NOT COVERED BY THE APPROVED CONSTRUCTION DOCUMENTS, WHEREIN THE FINISHED WORK WILL NOT PROCEEDING WITH THE WORK, PER 2019 CBC SECTIONS 107 AND 116.

CONSTRUCTION TECHNIQUES, MATERIALS AND FINISHES TO BE INSTALLED AS REQUIRED BY THE APPROPRIATE CODE AUTHORITIES. INSTALLATION SHALL FOLLOW THE STANDARDS OF THE INDUSTRY IN ADDITION TO MEETING OR EXCEEDING THE DESIGN STANDARDS.

COMPLY WITH THE 2019 CBC, A CHANGE ORDER DETAILING AND SPECIFYING THE REQUIRED WORK SHALL BE COMBUSTIBLE OR APPLY SUBMITTED TO AND APPROVED BY OS THE PROPERTY OF TREATED MATERIALS.

FIRE DEPARTMENT NOTES

<u>OWNER FURNISHED ITEMS</u>

WARRANTIES

<u>FIRESTOPPING</u>

INSTALLATION.

STRUCTURAL NOTES

WORK INDICATED AS "OWNER

APPROVAL OF THIS PROJECT.

FURNISHED/CONTRACTOR INSTALLED", AND "OWNER

APPLICABLE CODES AND REGULATORY REQUIREMENTS

INDICATED WITHIN THESE DOCUMENTS AND SHALL BE

INSTALLED AND FULLY OPERATIONAL PRIOR TO FINAL

FURNISHED/OWNER INSTALLED" SHALL MEET ALL

ALL WARRANTY DOCUMENTATION AS REQUIRED BY

CONTRACT DOCUMENTS SHALL BE TURNED OVER

ALL PENETRATIONS THROUGH FIRE-RATED FLOORS

UNDERWRITERS LABORATORY TESTED "THROUGH

PENETRATION FIRE-STOP SYSTEM" RATED EQUAL

TO OR GREATER THAN THE FIRE RATING OF THE

APPLICABLE FIRE STOP SYSTEM DESIGNS TO BE

RECORD AND OSHPD FIRE MARSHAL PRIOR TO

REVIEWED AND APPROVED BY THE INSPECTOR-OF-

THE CONTRACTOR SHALL PROVIDE A COPY OF ALL

APPROVED TESTED, LISTED DESIGNS ON THE JOB

"WHEN INSTALLING DRILLED IN ANCHORS AND/OR

POWDER DRIVING PINS IN EXISTING NO-PRESTRESSED

REINFORCED CONCRETE. USE CARE AND CAUTION TO

REINFORCEMENT BARS. WHEN INSTALLING THEM INTO

TENSIONED) LOCATE THE PRESTRESSED TENDONS BY

TENDONS DURING INSTALLATION. MAINTAIN A MINIMUM

EXISTING PRESTRESSED CONCRETE (PRE- OR POST-

USING A NON-DESTRUCTIVE METHOD PRIOR TO

INSTALLATION. EXERCISE EXTREME CARE AND

CAUTION TO AVOID CUTTING OR DAMAGING THE

REINFORCEMENT AND THE DRILLED-IN ANCHOR

CLEARANCE OF ONE INCH BETWEEN THE

SITE FOR USE BY "OSHPD FIELD PERSONNEL"

AVOID CUTTING OR DAMAGING THE EXISTING

AND WALLS SHALL BE FIRE- STOPPED WITH AN


TO THE OWNER BEFORE FINAL PAYMENT.

FLOOR OR WALL BEING PENETRATED.

EVERY ROOM OR SPACE THAT IS AN ASSEMBLY OCCUPANCY (GYM); SHALL HAVE THE OCCUPANT LOAD OF THE ROOM OR SPACE POSTED IN A CONSPICUOUS PLACE, NEAR THE MAIN EXIT OR EXIT ACCESS DOORWAY FROM THE ROOM OR SPACE. POSTED SIGNS SHALL BE OF AN APPROVED LEGIBLE PERMANENT DESIGN AND BE MAINTAINED BY THE OWNER OR THE OWNER'S AUTHORIZED AGENT.

IN EVERY A, E, I, R-1, R-2.1, R-3.1 AND R-4 OCCUPANCIES ALL DECORATIVE MATERIALS SHALL BE OF NON-COMBUSTIBLE OR APPROVED FLAME RETARDANT

THIS PERMIT DOES NOT INCLUDE ANY HIGH-PILE STORAGE (PER CFC) OR RACK STORAGE OVER 8 FEET IN HEIGHT. ANY SUCH PROPOSED STORAGE WILL REQUIRE SUBMITTAL OF PLANS AND APPLICATION FOR PERMITS.

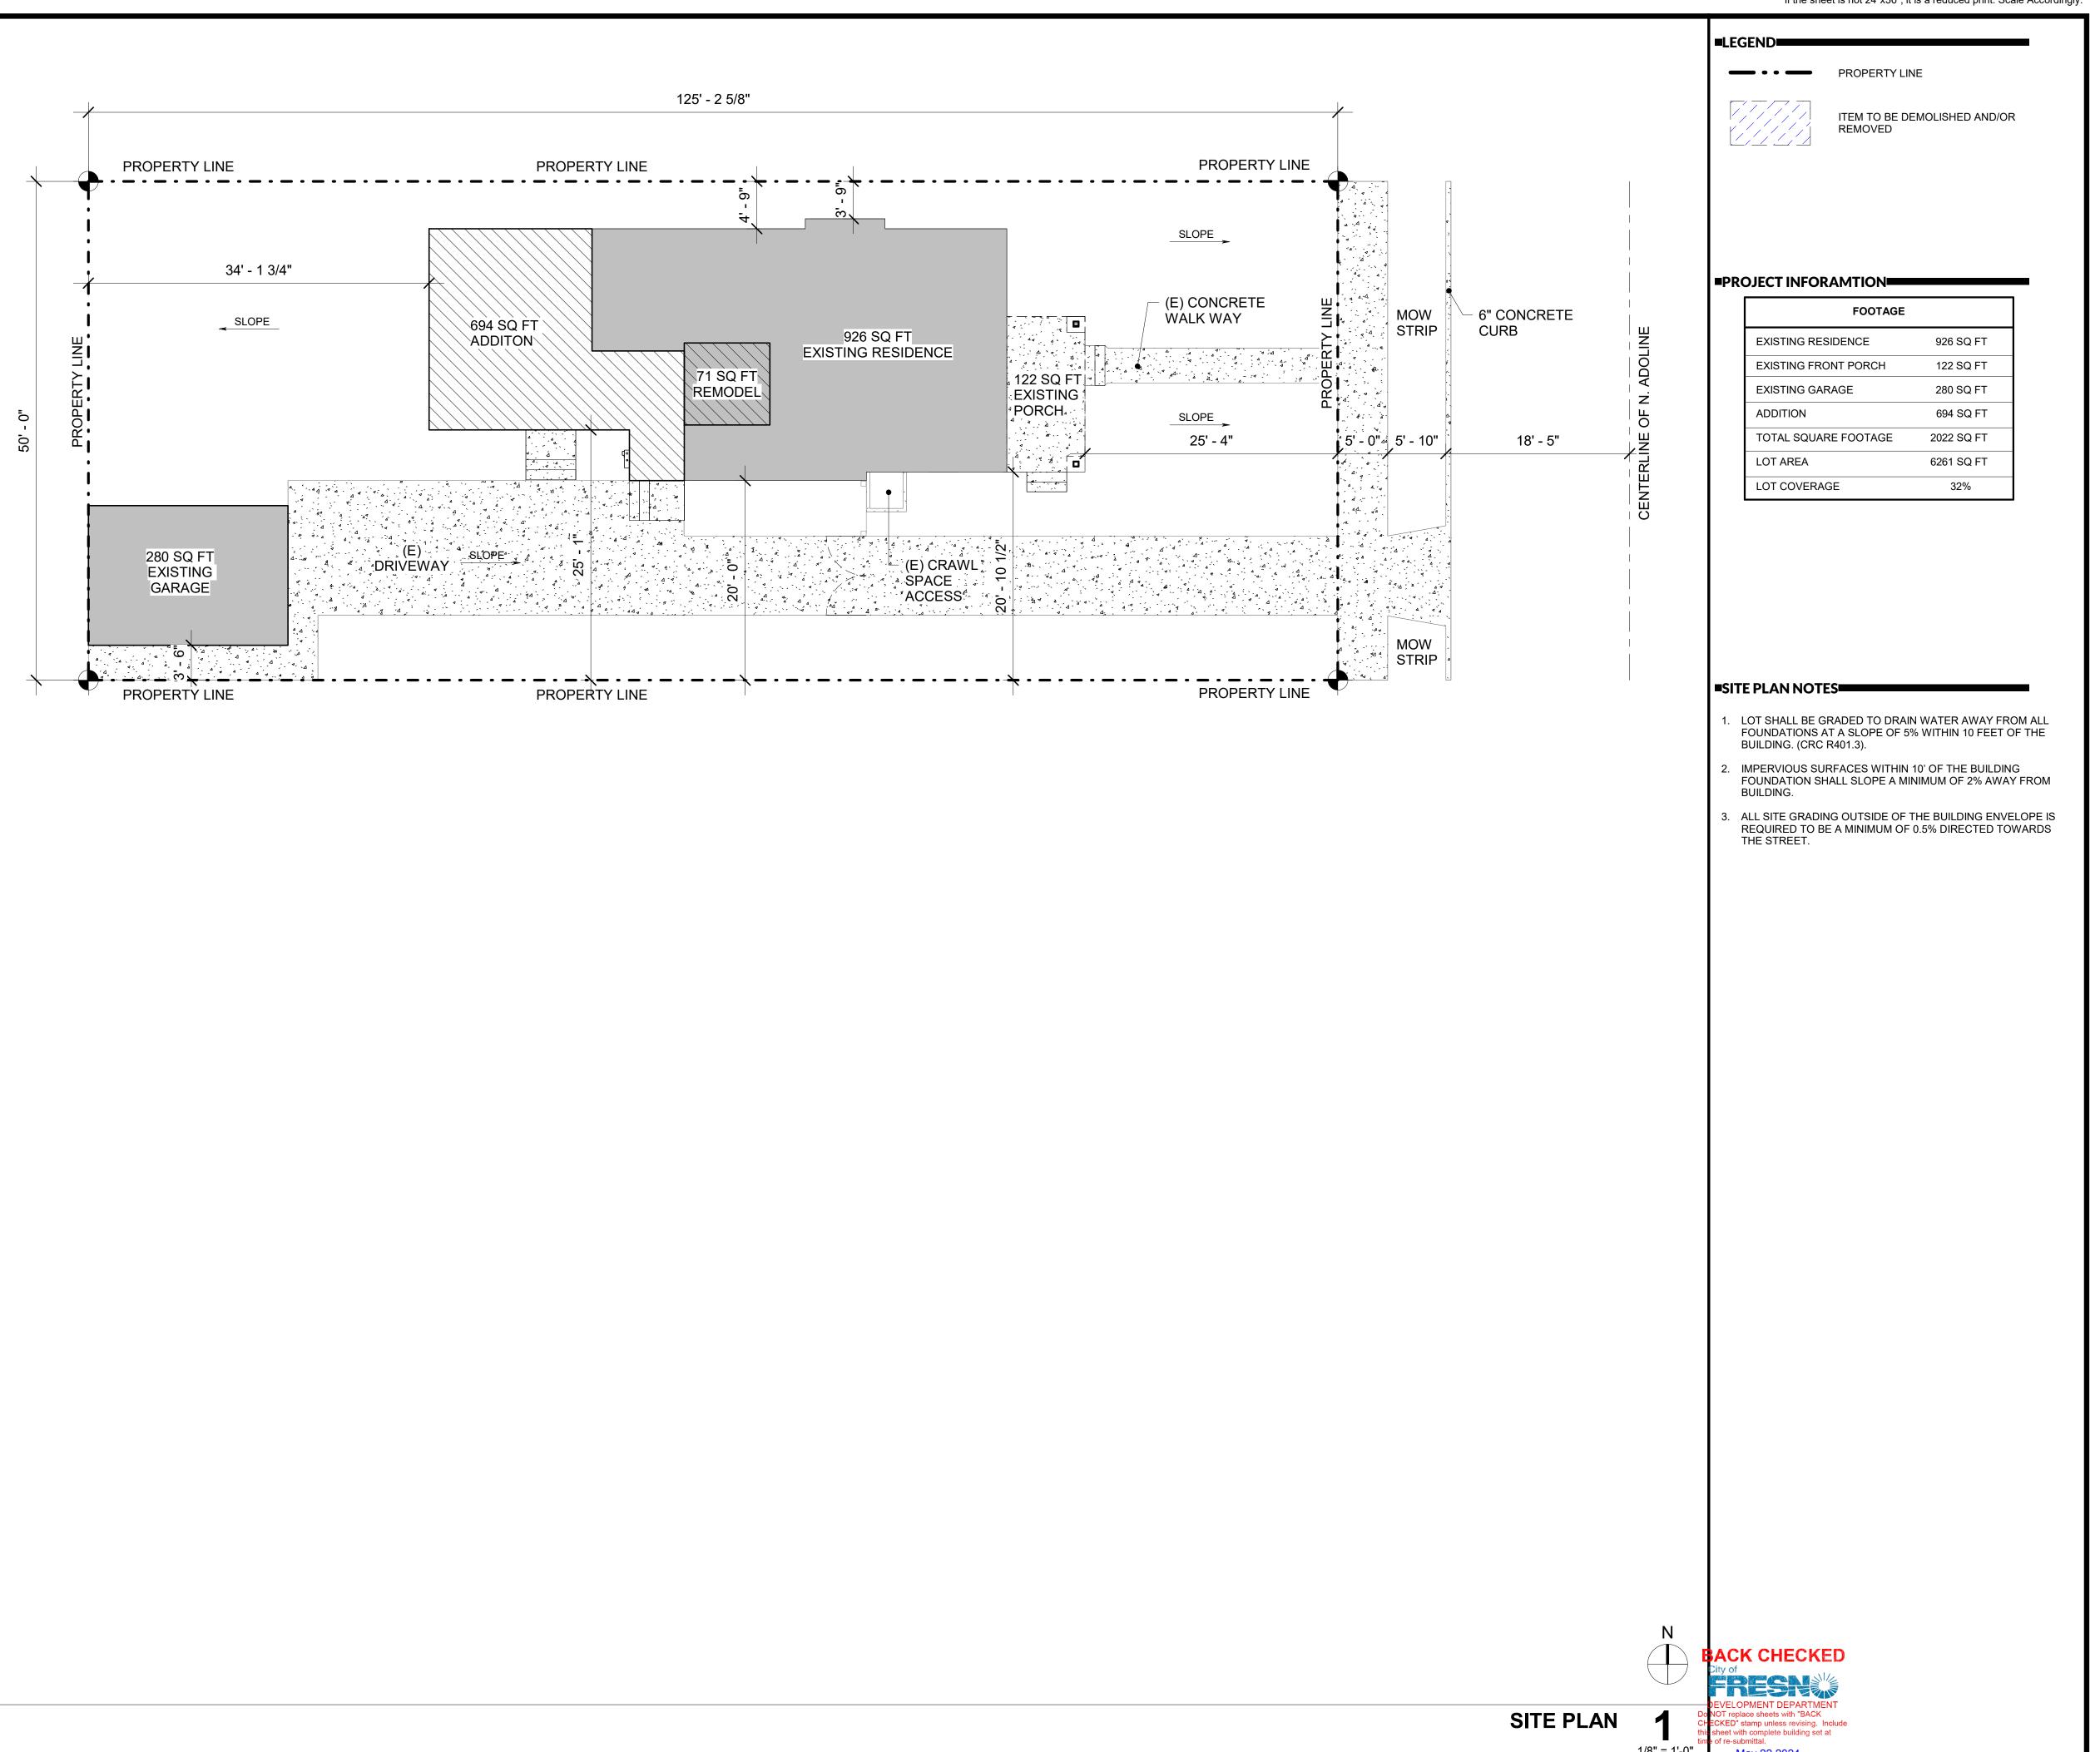

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Hellary Rodriguez

PROJECT

LEAP RESIDENCE ADDITION AND REMODEL

815 N. ADOLINE AVE. FRESNO, CA 93728

Project Number: 1001001

Revisions Issued:


No. Issued

Agency Approval:

Sheet Title: SITE PLAN

Sheet Number:

11 10

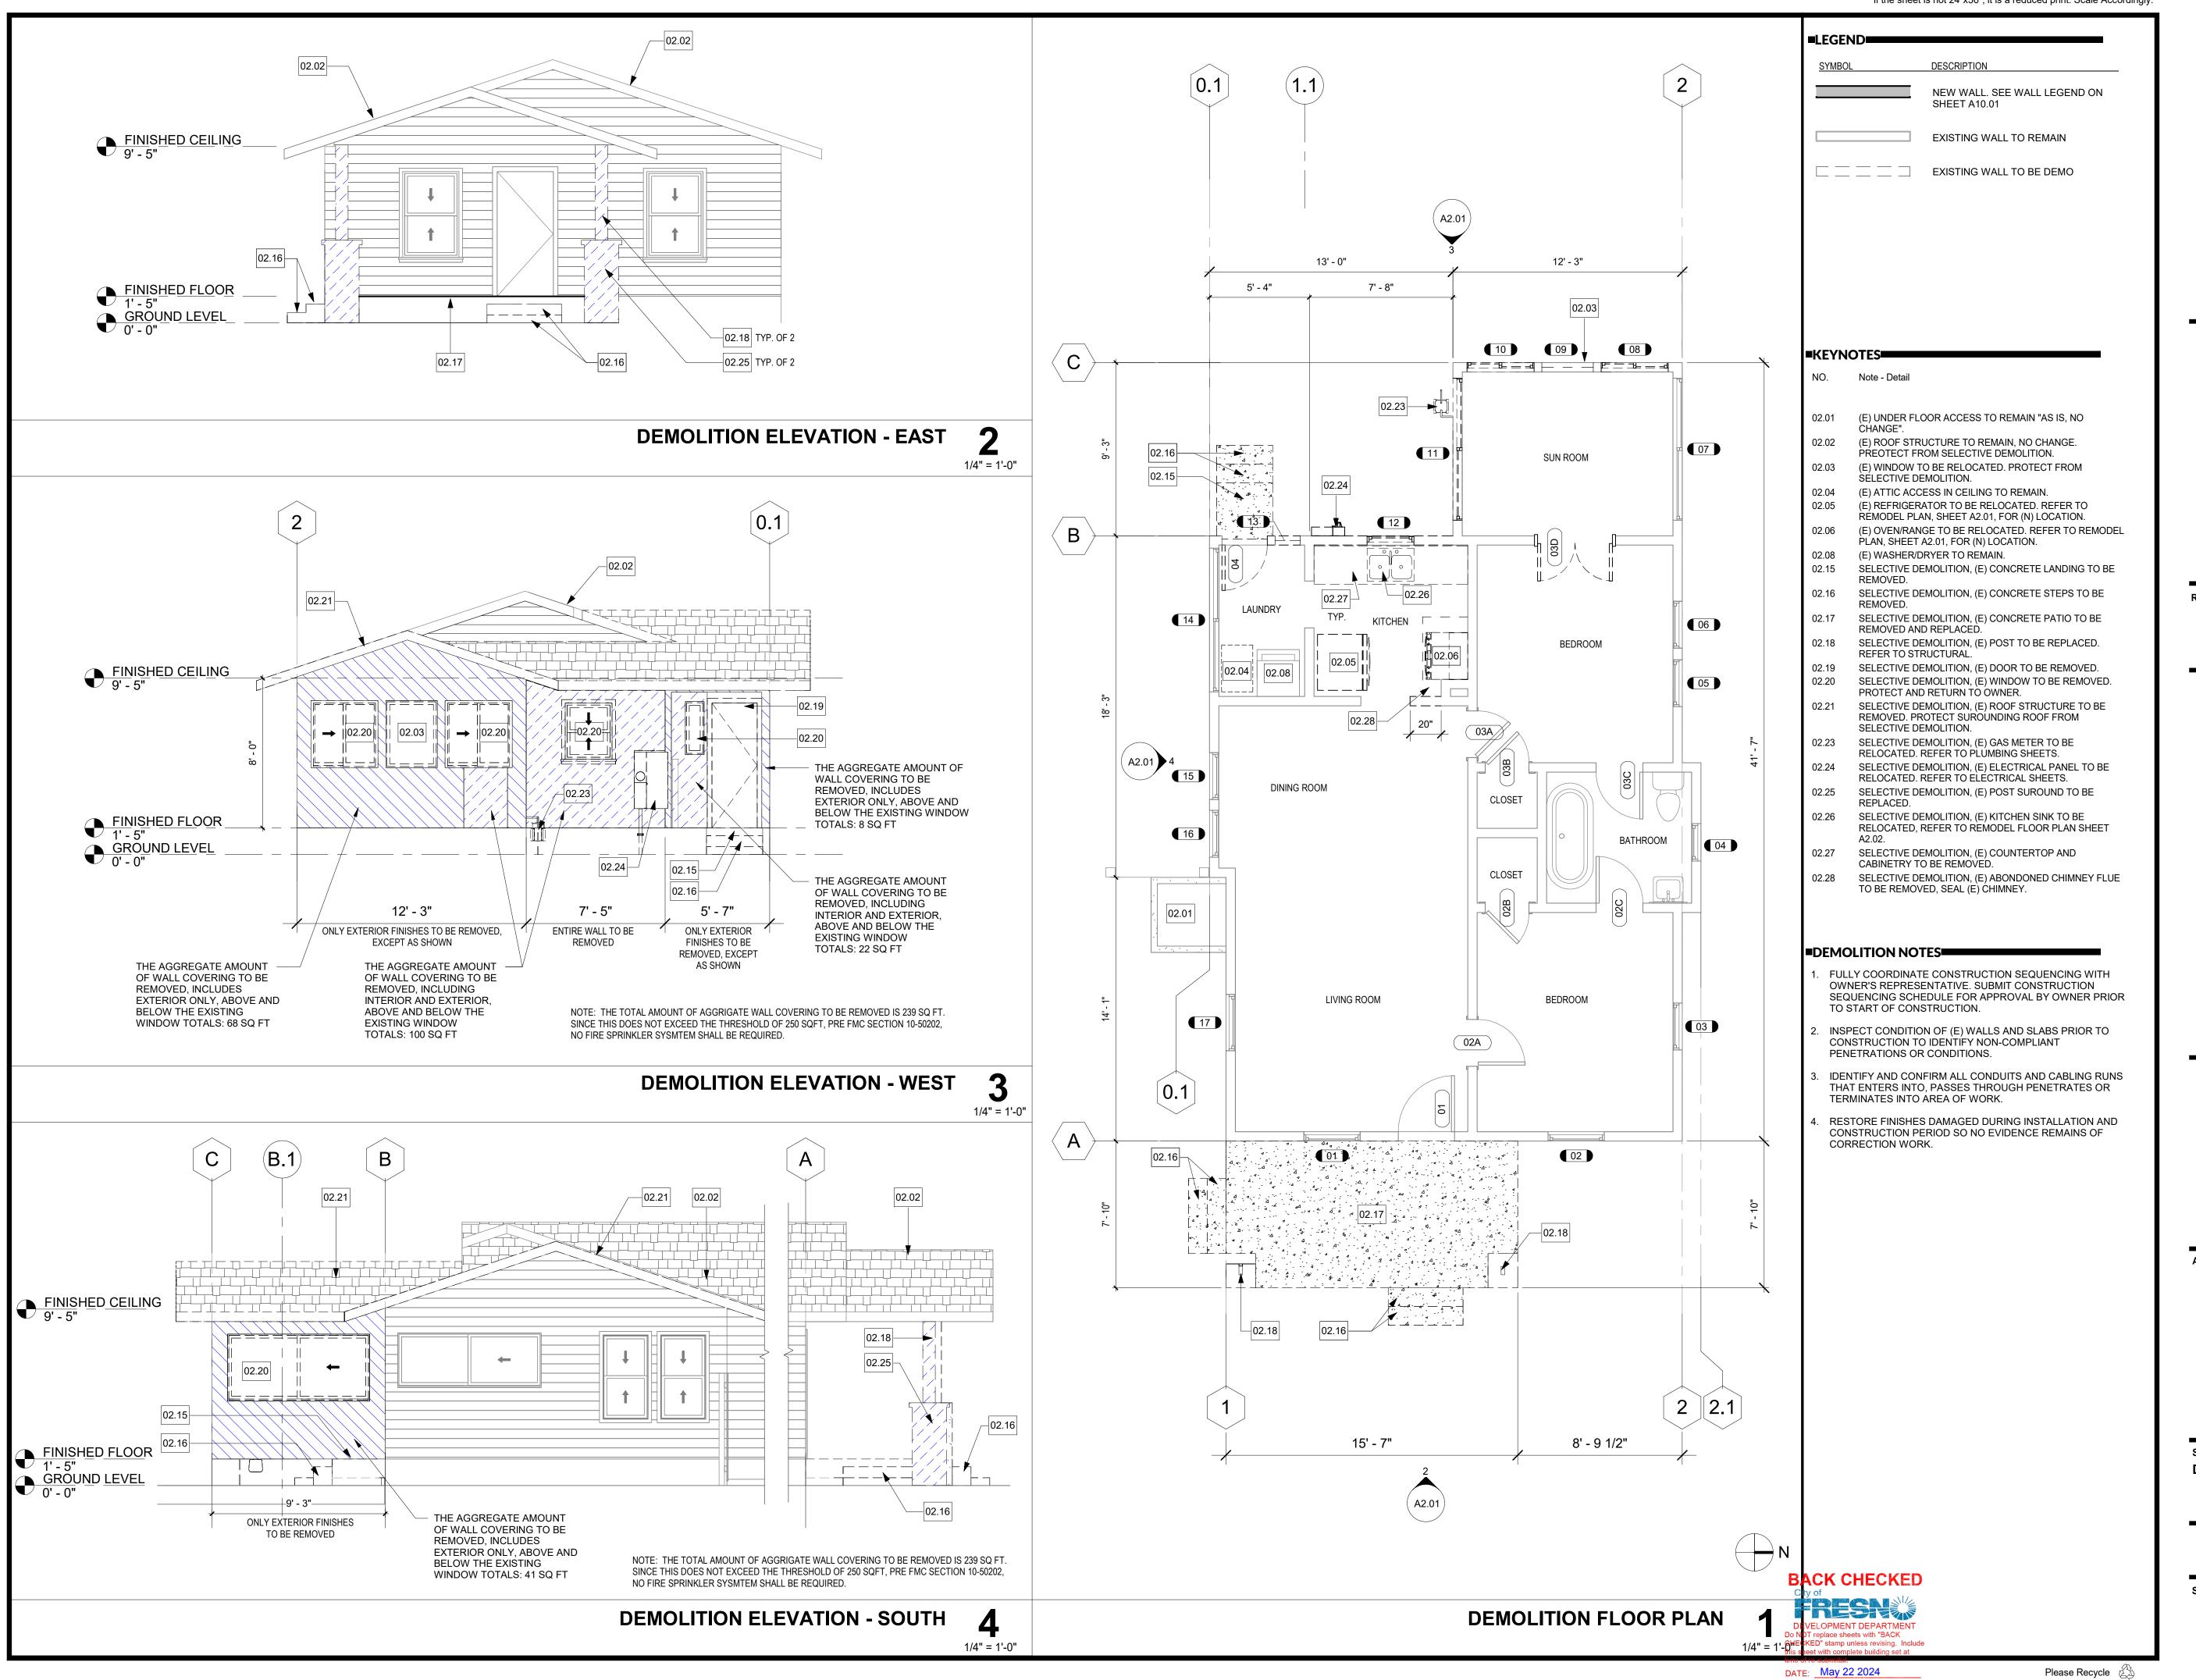

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Sheet Title: **DEMOLTION FLOOR PLAN**

Sheet Number:

■EXTERIOR DOORS

DOORS TO BE CERTIFIED AND LABLED.

X 2" SCREWS @ EACH SHIM.

- 2. ALL EXTERIOR DOORS SHALL BE DEADBOLTED.
- 3. GLASS DOORS SHALL HAVE DUAL PANE, TEMPERED GLASS. 4. STEEL PLATE SHALLL BE INSTALLED @ DEAD BOLT STRIKER WITH SOLID SHIMS 6" ABOVE & BELOW STRIKER WITH (2) #8
- 5. 1" MAX.STEPDOWN MEASURED FROM TOP OF THRESHOLD TO EXTERIOR LANDING.
- 6. ALL EXTERIOR DOORS SHALL BE SOLID CORE WITH WEATHERSTRIPPING

■WINDOWS GLAZING

- 1. WINDOWS TO BE CERTIFIED AND LABLED.
- 2. ALL GLAZING TO BE DUAL PANE.
- 3. GLAZING IN ENCLOSURES FOR, OR WALLS FACING, BATH TUBS AND SHOWERS WHERE THE BOTTOM EXPOSED EDGE OF THE GLAZING IS LESS THAN 60" MEASURED VERTICALLY ABOVE ANY STANDING OR WALKING SURFACE.

■ENERGY COMPLIANCE

ENERGY COMPLIANCE

WALL INSULATION: R-15 UNFACED BATT W/ 1/2" DENSGLASS SHEATHING ATTIC INSULATION: R-30 FLOOR INSULATION: R-19

WINDOWS: SHGC .67 U FACTOR .58

COMPLETED CF-4R FORM TO BE SUBMITTED PRIOR TO FINAL INSPECTION, SIGNED BY CERTIFIED HERS RATER, FOR FIELD VERIFICATION AND DIAGNOSTIC TESTING.

AFTER INSTALLING WATER HEATING SYSTEMS, FENESTRATION, AND HVAC EQUIPMENT, THE INSTALLER SHALL SUBMIT AND "INSTALLATION CERTIFICATE" (CF-6R FORM), COMPLETED AND SIGNED BY THE INSTALLER, LISTING THE EQUIPMENT INSTALLED, (MANUFACTURER, MODEL, AND EFFICIENCIES, U-VALUES AND SHGC-VALUES, ETC.) AND THAT IT MEETS OR EXCEEDS THE REQUIREMENTS OF THE ENERGY DOCUMENTATION. (CEES SECTION 10-103(A)(3))

DOOR SCHEDULE					
DOOR NUMBER	DOOR WIDTH	DOOR HEIGHT	FRAME TYPE / PANEL TYPE	Comments	
01	3' - 0"	6' - 8"	HINGED		
02A	2' - 6"	6' - 8"	HINGED		
02B	2' - 4"	6' - 8"	HINGED		
02C	2' - 6"	6' - 8"	HINGED		
03A	2' - 6"	6' - 8"	HINGED		
03B	2' - 4"	6' - 8"	HINGED		
03C	2' - 6"	6' - 8"	HINGED		
03D	4' - 0"	6' - 8"	HINGED	TO BE REMOVED	
04	2' - 5"	6' - 8"	HINGED	TO BE REMOVED	
04A	2' - 6"	6' - 8"	HINGED		
04B	2' - 8"	6' - 8"	HINGED		
05A	2' - 6"	6' - 8"	HINGED		
05B	2' - 4"	6' - 8"	HINGED		
06A	2' - 6"	6' - 8"	HINGED		
06B	4' - 0"	6' - 8"	HINGED		
06C	2' - 6"	6' - 8"	HINGED		
06D	2' - 6"	6' - 8"	HINGED		

		WINDOW SCHEDU	LE
WIDTH	HEIGHT	CONSTRUCTION TYPE	Comments
		1	
	4' - 7"	<u>'</u>	
3' - 0"	4' - 7"	VINYL FRAME, DOUBLE HUNG	EXISTING TO REMAIN.
2' - 6"	4' - 7"	VINYL FRAME, DOUBLE HUNG	EXISTING TO REMAIN.
2' - 0"	3' - 0"	VINYL FRAME, DOUBLE HUNG	EXISTING TO REMAIN.
2' - 6"	4' - 7"	VINYL FRAME, DOUBLE HUNG	EXISTING TO REMAIN.
2' - 6"	4' - 7"	VINYL FRAME, DOUBLE HUNG	EXISTING TO REMAIN.
7' - 7"	3' - 7"	VINYL FRAME, SLIDER	EXISTING TO REMAIN.
3' - 7"	3' - 7"	VINYL FRAME, SLIDER	EXISTING TO BE RELOCATED. ADD 5M COAT TO FROST EXISTING GLASS
2' - 9"	3' - 7"	VINYL FRAME, FIXED	EXISTING TO BE RELOCATED
3' - 7"	3' - 7"	VINYL FRAME, SLIDER	EXISTING TO BE REMOVED
7' - 7"	3' - 7"	VINYL FRAME, SLIDER	EXISTING TO BE RELOCATED.
2' - 6"	3' - 0"	VINYL FRAME, DOUBLE HUNG	EXISTING TO BE REMOVED
1' - 0"	2' - 10"	VINYL FRAME, FIXED	EXISTING TO BE RELOCATED. ADD 5M COAT TO FROST EXISTING GLASS
7' - 8"	2' - 11"	VINYL FRAME, SLIDER	EXISTING TO REMAIN.
2' - 6"	4' - 7"	VINYL FRAME, DOUBLE HUNG	EXISTING TO REMAIN.
2' - 6"	4' - 7"	VINYL FRAME, DOUBLE HUNG	EXISTING TO REMAIN.
3' - 0"	4' - 7"	VINYL FRAME, DOUBLE HUNG	EXISTING TO REMAIN.
	3' - 0" 3' - 0" 2' - 6" 2' - 6" 2' - 6" 2' - 6" 7' - 7" 3' - 7" 7' - 7" 2' - 6" 1' - 0" 7' - 8" 2' - 6" 2' - 6"	3' - 0"	WIDTH HEIGHT CONSTRUCTION TYPE 3' - 0" 4' - 7" VINYL FRAME, DOUBLE HUNG 3' - 0" 4' - 7" VINYL FRAME, DOUBLE HUNG 2' - 6" 4' - 7" VINYL FRAME, DOUBLE HUNG 2' - 6" 4' - 7" VINYL FRAME, DOUBLE HUNG 2' - 6" 4' - 7" VINYL FRAME, DOUBLE HUNG 7' - 7" 3' - 7" VINYL FRAME, SLIDER 3' - 7" VINYL FRAME, SLIDER 2' - 9" 3' - 7" VINYL FRAME, SLIDER 2' - 9" 3' - 7" VINYL FRAME, SLIDER 2' - 6" 3' - 7" VINYL FRAME, DOUBLE HUNG 1' - 0" 2' - 10" VINYL FRAME, FIXED 7' - 8" 2' - 11" VINYL FRAME, SLIDER 2' - 6" 4' - 7" VINYL FRAME, DOUBLE HUNG 2' - 6" 4' - 7" VINYL FRAME, DOUBLE HUNG 2' - 6" 4' - 7" VINYL FRAME, DOUBLE HUNG

INSTALLED FENESTRATION PRODUCTS, INCLUDING GLAZED DOORS, SHALL HAVE AN AREA WEIGHTED AVERAGE U-FACTOR AND SOLAR HEAT GAIN COEFFICIENT (SHGC) MEETING THE APPLICABLE FENESTRATION VALUES IN CBC TABLE 150.1-A OR B AND SHALL BE DETERMINED IN ACCORDANCE WITH CBC SECTIONS 110.6(a)2 AND 110.6(a)3.

	(1.1)			SYMBOL	DESCRIPTION
	5' - 1"	- 2"			NEW WALL. SEE WALL LEGEND ON SHEET A10.01
-	A5.01 1				EXISTING WALL TO REMAIN
	A6.1	2A TYPICAL FOR			EXISTING WALL TO BE DEMO
	11	ALL (N) EXTERIOR WALLS			
<u>C.1</u> — — — —			*	NO. Note - Detail	
B.1 26.01 A6.10 is so 22.02	22.04 3'-0" 1'-8" 4c A5.02 4a 05A 22.06 4b 17" 19"	1A	01 01 01 IASTER ATHROOM "1-10" "0-12	03.02 CAST-IN PLACE 7" MAX. AND 4 06.01 SOLID SURFAL OFCI. 06.02 ROUGH CARP D.F.#2 OR BET 08.01 ACCESS DOO REFER TO ST 10.01 MISCELLANEC ENCLOSURE. RECOMENDA 22.01 PLUMBING, LA TO PLUMBING, W 22.02 PLUMBING, SI 22.04 PLUMBING, SI 22.04 PLUMBING, RI PLUMBING SH 22.05 PLUMBING, LA PLUMBING, LA PLUMBING, LA PLUMBING, LA PLUMBING, LA MOUNTED. RE	RS AND FRAMES, 18x24 FRAMED OPENING. RUCTUAL FOR FRAMING. DUS SPECIALTIES, GLASS SHOWER INSTALL PER MANUFACTURER TIONS. AVATORY, COUNTERTOP MOUNTED REFER IS SHEETS ATER CLOSET, REFER TO PLUMBING SHEETS HOWER DRAIN, REFER TO PLUMBING SHEETS ELOCATED GAS METER. REFER TO IEETS AVATORY, WALL MOUNTED. REFER TO
E E E E E E E E E E E E E E E E E E E	5c A5.02 5a 42 1B	TB) TYPICAL FOR ALL INFILLS IN (E) WALLS			
B				■GENERAL NOTES	
03.01	(1B) KITCHEN				TION EXC (GAR) TO BE MIN. R-38 RATING ISULATION EXC. (GAR.) TO BE MIN R-15
14	LAUNDRY	06			ENETRATIONS TO BE CAULKED AND
	43" 20"	BEDROOM TWO		3. SILL & EXTERIOR &	INTERIOR BEARING WALLS TO BE 2" X 10" AB @ 6'=0" O.C. MIN. 2 BOLTS
		05	•	PER PIECE WITH 1	BOLT WITHIN 6" OF EACH END. ONBEARING WALLS TO BE FASTENED
				WITH POWER DRIV	EN ANCHORS, 2 MAX. 3'-0" O.C. RTICAL FRAMING LUMBER TO BE
				DOUGLAS FIR #2 O	
A5.01 4	DINING ROOM	CLOSET	1 (A5.01)		H UNLESS FOUNDATION GRADE OR
16				7. COOKTOP CLEARA PROTECTED.	NCE, ALLOW 30" UNPROTECTED OR 24"
		CLOSET	04	WIRED W/ 110V SU BE UL. APPROVED LOCATIONS AND T	RS SHALL BE CEILING MOUNTED & DIRECT PPLY 3' MIN. FROM ANY AIR RETURN TO SEE ELECTRICAL PLAN SHEET E1.1 FOR YPE. 4X12 UNLESS OTHERWISE NOTED.
					S TO BE DOUGLAS FIR STD GRADE.
	LIVING ROOM	BEDROOM		CHECK & CONFIRM ALSO CHECK AND PRIOR TO START O	ENERAL & SUBCONTRACTORS ARE TO I ALL DIMENSIONS ON THESE PLANS CONFIRM ALL CONDITIONS AT SITE OF CONSTRUCTION DISCREPANCIES ARE TO OWNER FOR CORRECTIONS.
		ONE 03		WALL MATERIAL SI BY MATERIAL ADVI	EHIND CERAMIC TILE OR OTHER FINISH JBJECT TO WATER ARE CONSTRUCTED ERSELY AFFECTED BY WATER (IF GYP. T MUST BE APPROVED WP. BOARD 07 CBC 2509.
0.1				BE PROPERLY IDEI JOB TO BE PROVID U.B.C. 2511 (F).	CERTIFICATION OF GLULAM BEAMS MUST NTIFIED FOR THE LOCATION & SPECIFIC PED BEFORE FRAMING INSPECTION
A 03.02	101	02			ATION PLAN FOR HOLDOWNS AND ROOF R TIE & STRUT INFORMATION.
					O EXCEED 44" U.B.C. 106.3.2. CKING AT THE 10-FOOT INTERVALS AND
7 - 10	03.01			AT ALL OF THE FLC 708.21.	OOR AND CEILING LEVELS CBC SECTION
12"	12"			CONDUITS OR OTH EXTERIOR WALLS PASSAGE OF RODI CEMENT MORTAR,	AROUND PIPES, ELECTRICAL CABLES, IER OPENINGS IN SOLE/BOTTOM AT SHALL BE PROTECTED AGAINST THE ENTS BY CLOSING SUCH OPENINGS WITH CONCRETE MASONRY OR SIMILAR ED BY THE ENFORCING AGENCY.
	06.02	3		ENCLOSED WHEN DOCUMENTATION INSULATION INSPE	FRAMING MEMBERS SHALL NOT BE MOISTURE CONTENT EXCEEDS 19%. SHALL BE PROVIDED AT THE TIME OF CTION, CERTIFYING MOISTURE CONTENT BERS, FOLLOWING THE PROCEDURES ION 4.505.3 OF THE CALGREEN CODE.
	1	(A5.01) 2	2.1 N N CHECK	19. INSULATION PROD	UCTS WHICH ARE VISIBLY WET OR HAVE
	~		City of		ONTECT SHALL BE REPLACED OR PER THE MANUFACTURER'S DRYING NS, PRIOR TO ENCLOSURE OF WALL AND



1049 E. Manhattan Ave. / Fresno, CA 93720

Hillary Rodrigue: 559.476.6806 • Hillary.drafting@gmail.com

PROJECT

LEAP RESIDENCE **ADDITION AND REMODEL**

815 N. ADOLINE AVE. FRESNO, CA 93728

Project Number: 1001001

Revisions Issued:

Agency Approval:

Sheet Title: REMODEL FLOOR PLAN, WINDOW & DOOR


Sheet Number:

SCHEDULES

Do NOT replace sheets : CHECKE**D** starmp unles

REMODEL FLOOR PLANFILES

ELOR CAVITIES. (CALGreen 4.505.3)

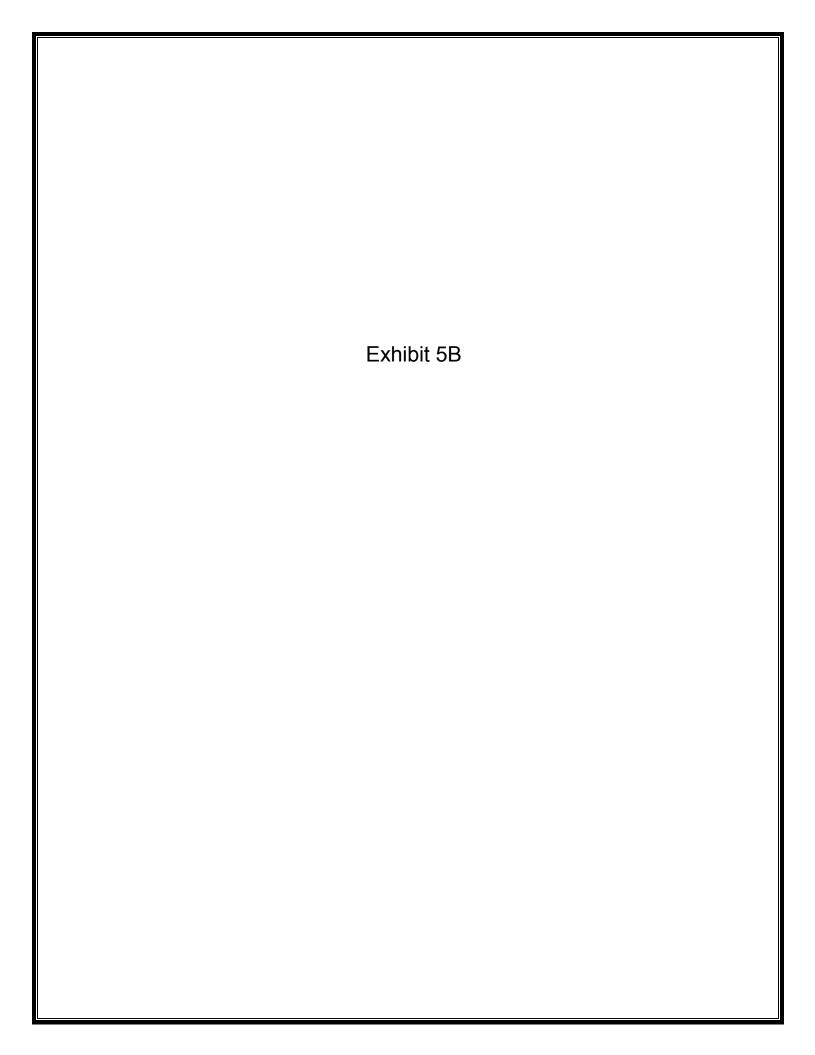


Site Plan for 712 N Van Ness Ave, Fresno, CA 932728


PROPOSED USE:


FOUR UNITS IN (2) TWO STORY BUILDINGS SIDE BY SIDE. ALL FOUR UNITS ARE THREE BEDROOM TWO BATH 1040 SQUARE FEET EACH.


PARKING

FOUR ONSITE COVERED PARKING SPOTS AND FOUR ONSITE UNCOVERED PARKING SPOTS.

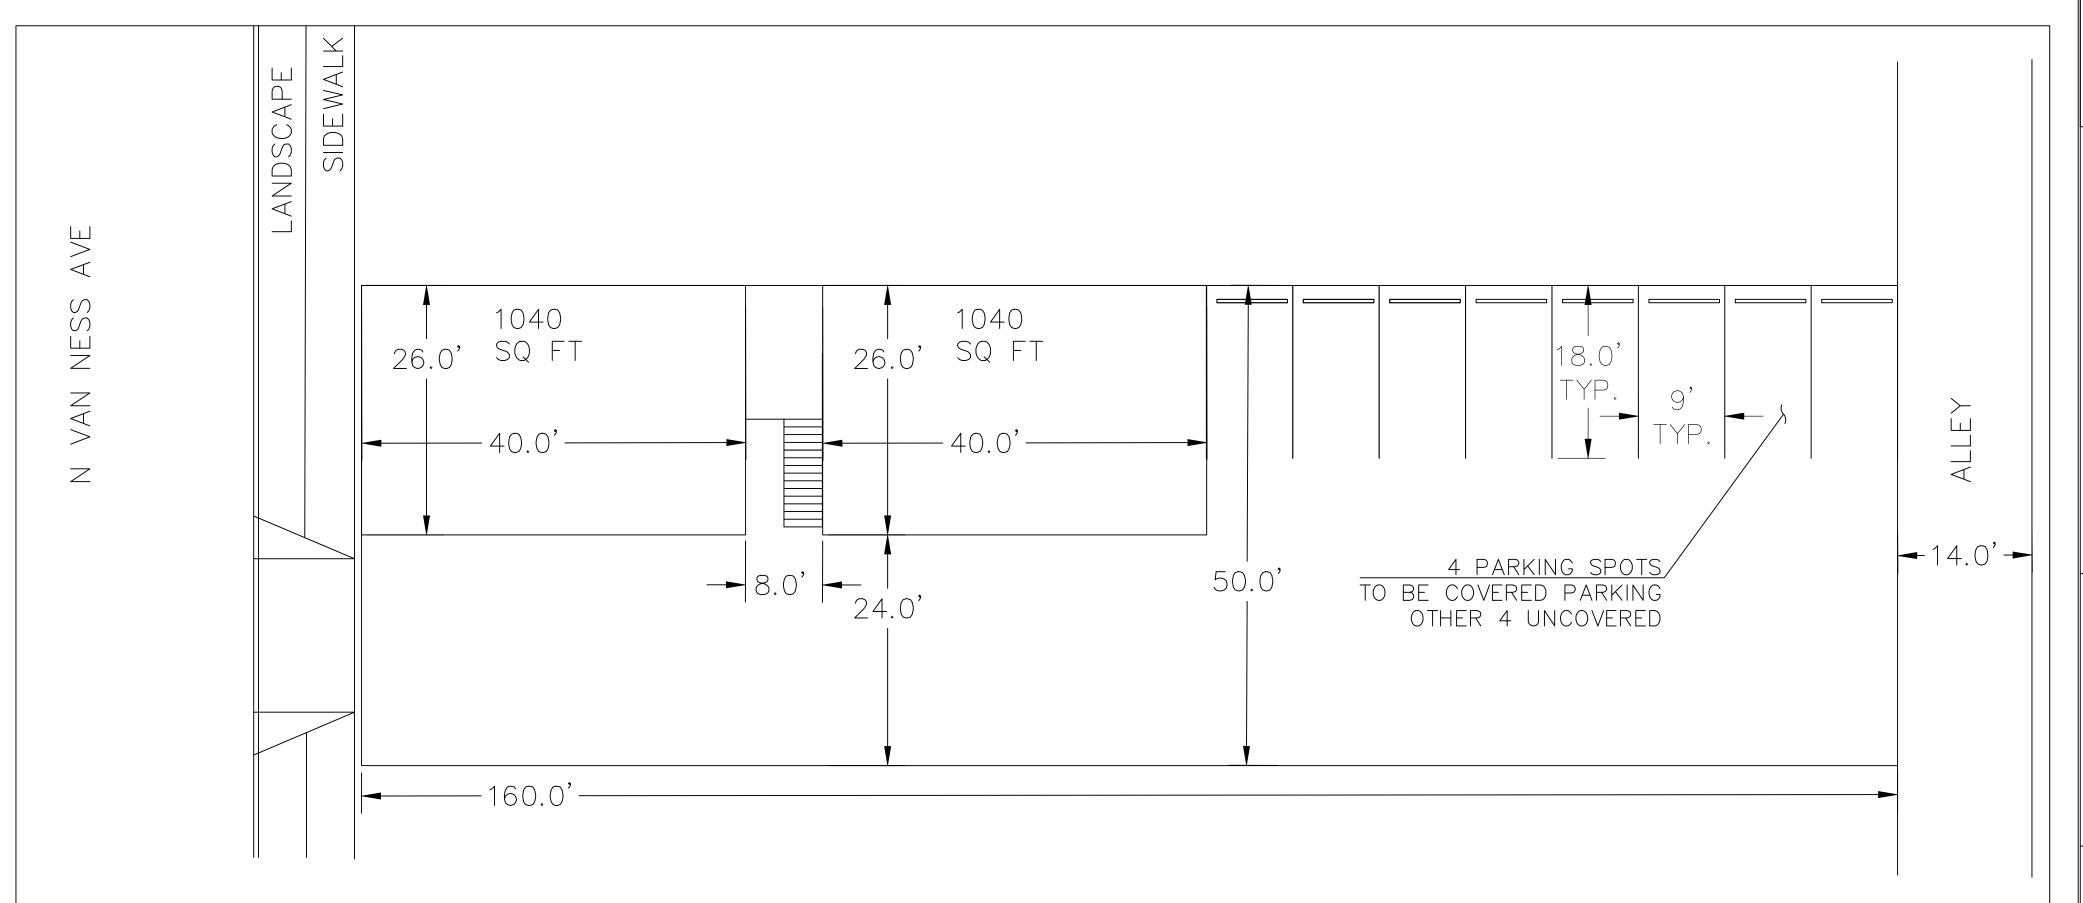

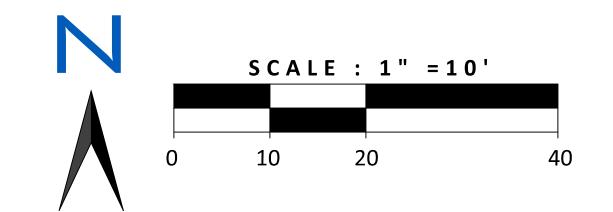

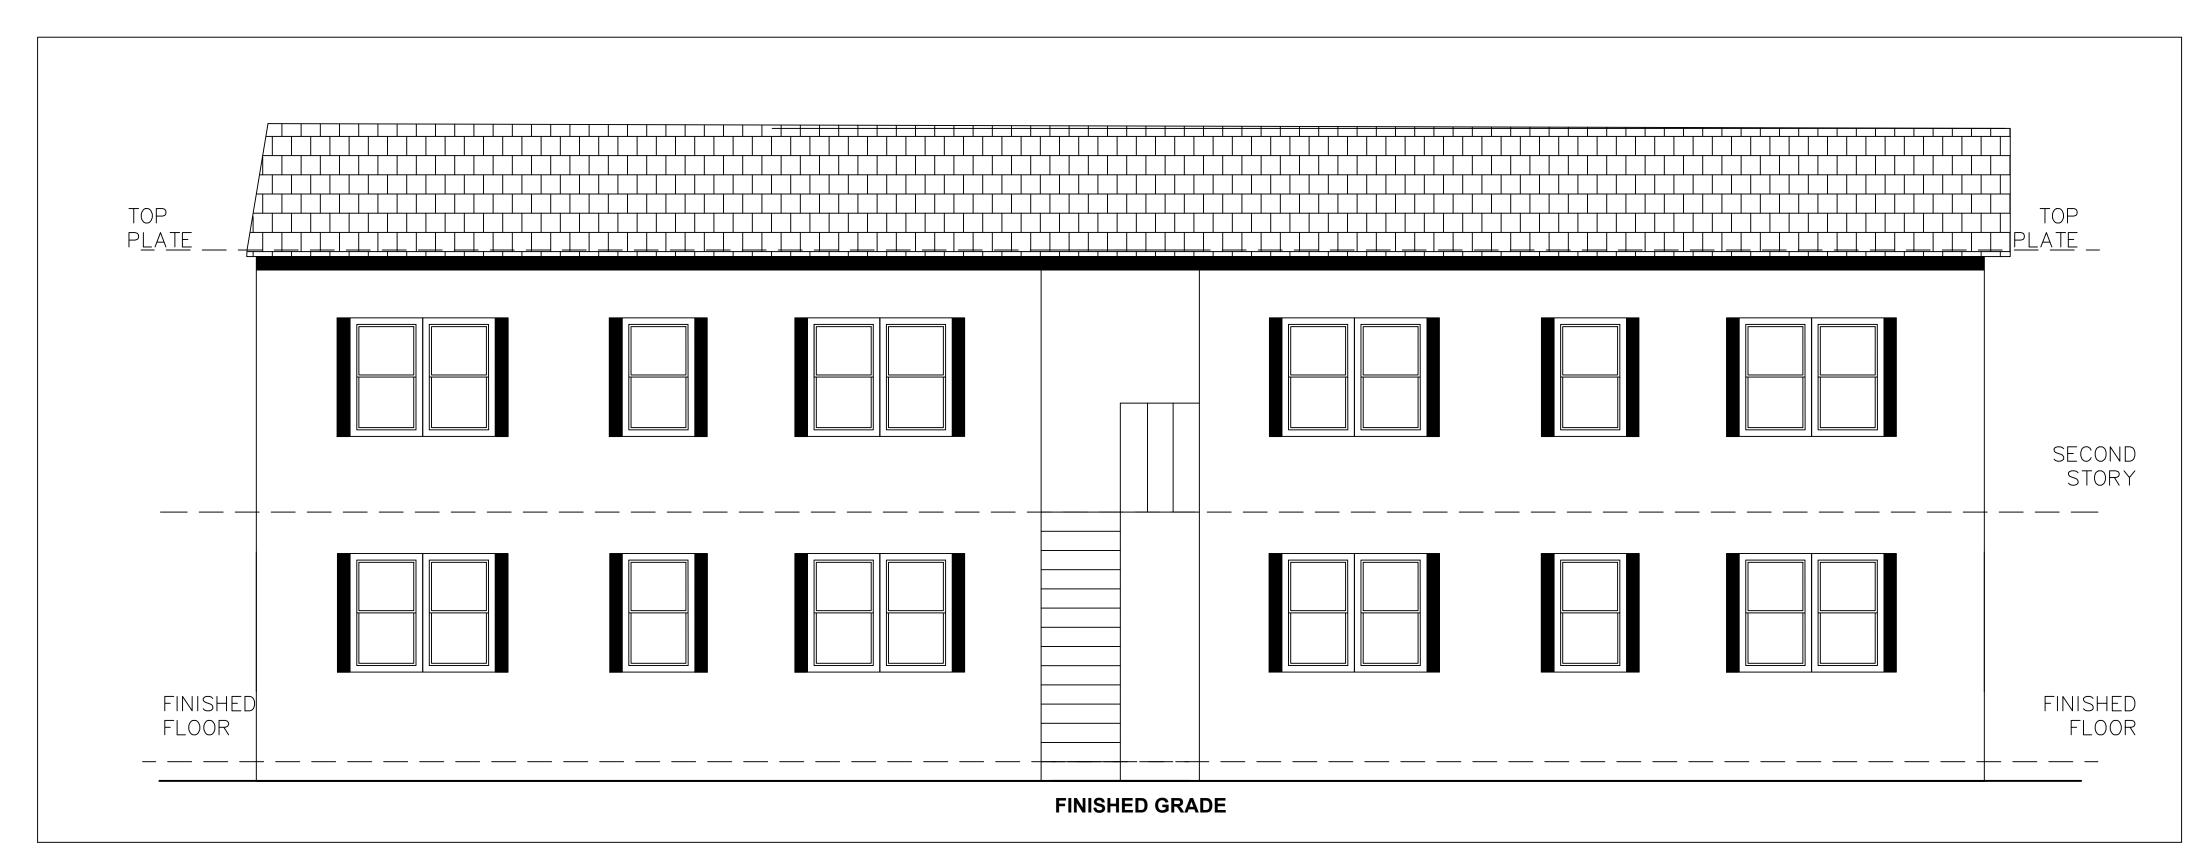

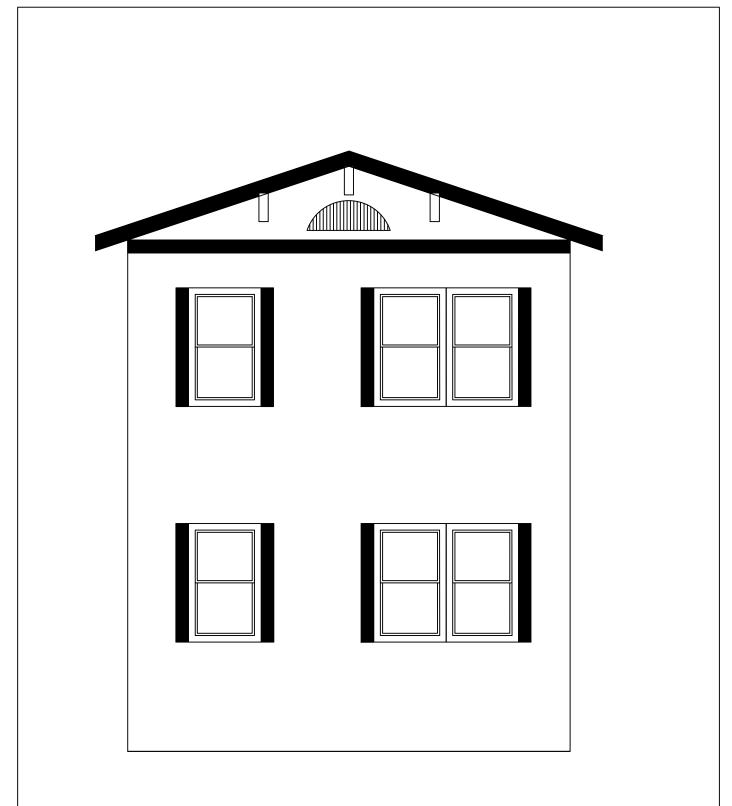

SIDE ELEVATION

ELEVATION FACING STREET


TOTAL ENGINEERING SOLUTIC
710 VAN NESS AVE, SUITH
FRESNO, CA
TEL: 559-265-2283
EMAIL: TEAM@TOTALENGSOLUTIONS.CO

PREPARED FOR:

AN NESS AVE, FRESNO, CA 97328

6/15/2024
Scale
ON_SHEET
Sheet No.
1 OF 1

File No.
2024_FVN

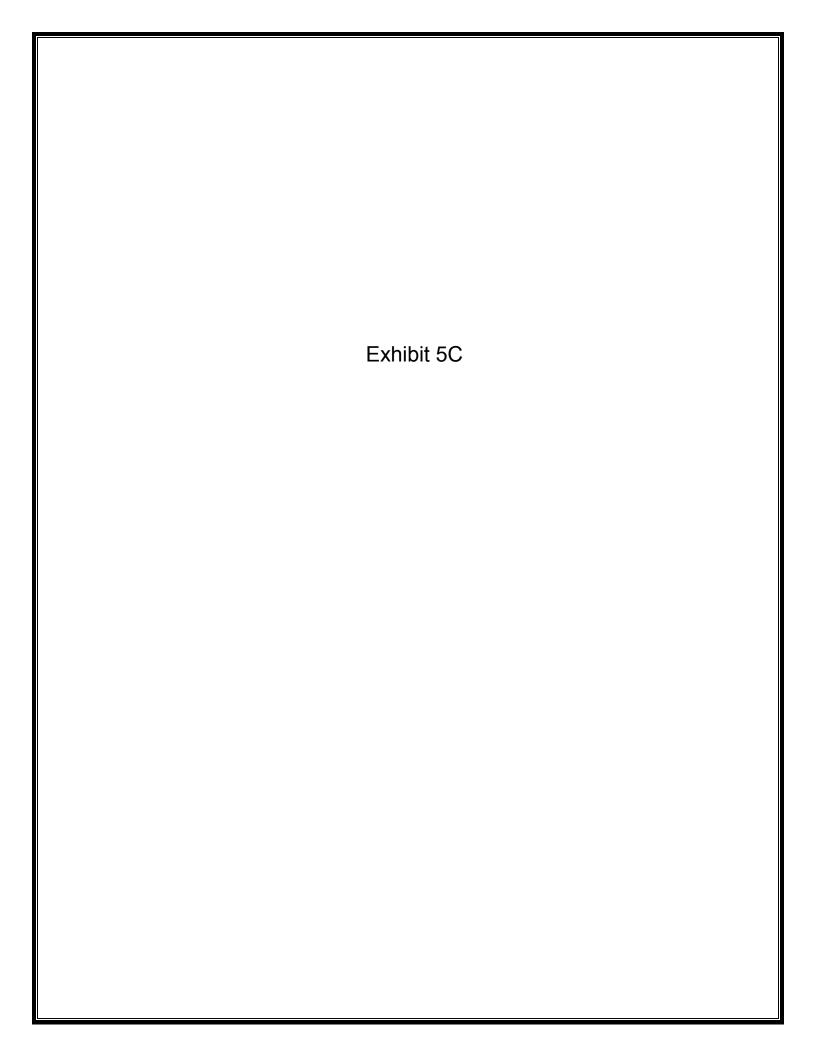





Fresno | San Francisco

5547 N. Golden State Blvd. Fresno, CA USA 93722 T 559 275 7500 F 559 275 4431 cnisign.com

Contact: Arlen Tanielian arlen@cnisign.com

Repeat Performance 1429 N. Van Ness Ave. Fresno CA 93728

This sign is intended to be installed in accordance with the requirements of article 600 of the national electric code including proper grounding and bonding of the sign.

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No.	Description		Date
Pro	ject Number:		Scale:
2404	45	As	s Noted
Sheet	Title:		
Site <i>N</i>	Лар		
Sheet	Number:		
1			
Appro	oved By:		Date:
			5-22-24











REMOVE EXISTING CABINET SIGN


REMOVE EXISTING ALARM BOX



REAR ELEVATION ROOF &

REAR ELEVATION – EXISTING CONDITIONS.



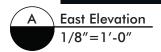



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No.	Description		Date
Pro	ject Number:		Scale:
240	45	A:	s Noted
Shee	t Title:		
Sign	A & B - South Ele	vation	
Shee	t Number:		
2			

Approved By:









Date:

5-22-24



REMOVE EXISTING CABINET SIGN

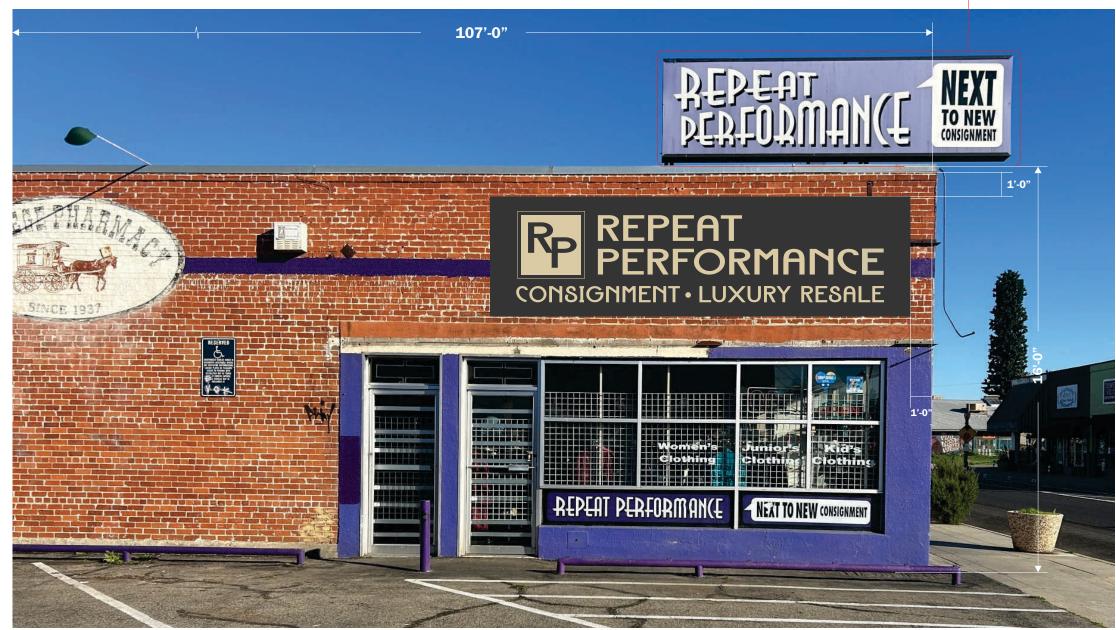

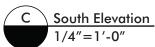



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No.	Description		Date	
Pro	ject Number:		I Scale:	
240	-	A:	As Noted	
Shee	t Title:			
Sign	C - South Elevatio	n		
Shee	t Number:			
3				
Appro	oved By:		Date:	
			5-22-24	











Dimensions

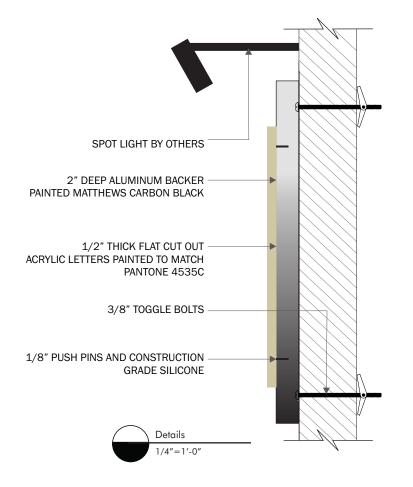



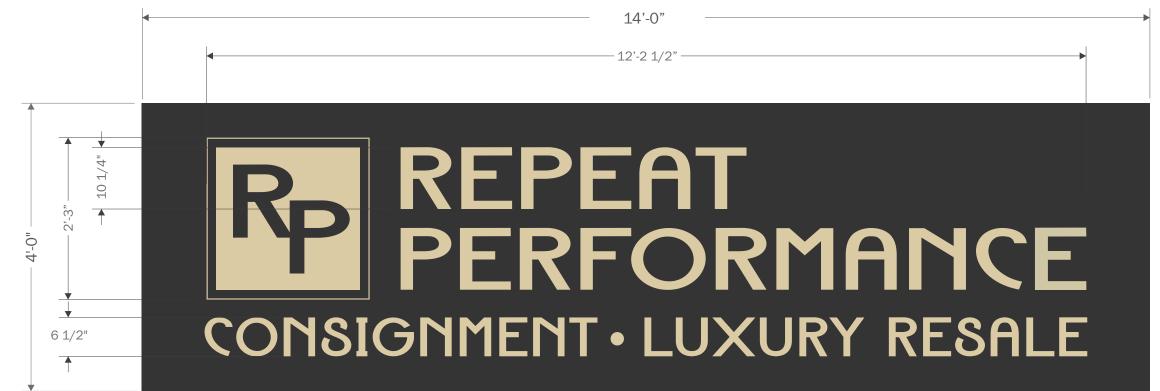



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and cann	ot be used in whole or part	t without pri	or written consent.
No.	Description		Date
Pro	ject Number:	:	Scale:
2404	45	A:	s Noted
Sheet	: Title:		
Sign	A - Dimensions &	Details	
Sheet	Number:		
4			
Appro	oved By:		Date:







5-22-24







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No.	Description		Date
Pro	ject Number:		Scale:
2404	45	A:	Noted
Sheet	: Title:		
Sign	B - Dimensions &	Details	
Sheet	Number:		
5			
Appro	oved Bv:		Date:









5-22-24



Dimensions

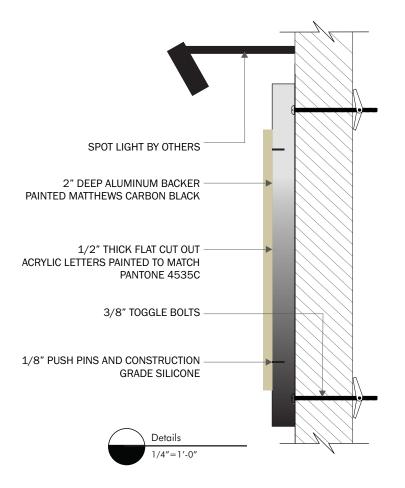



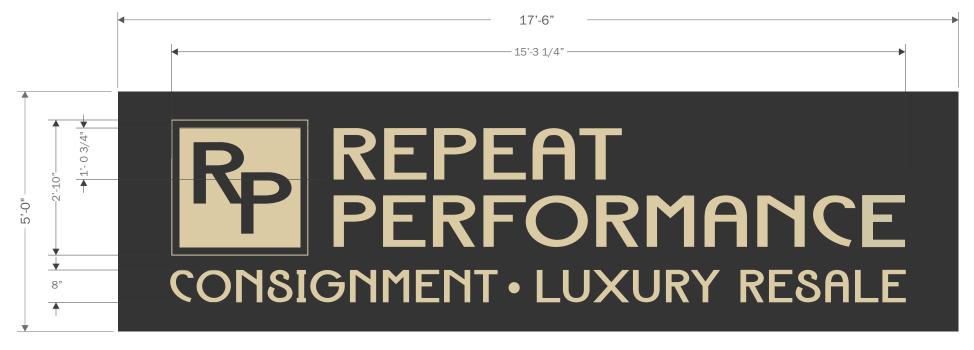

Sq. Ft.: 87.5



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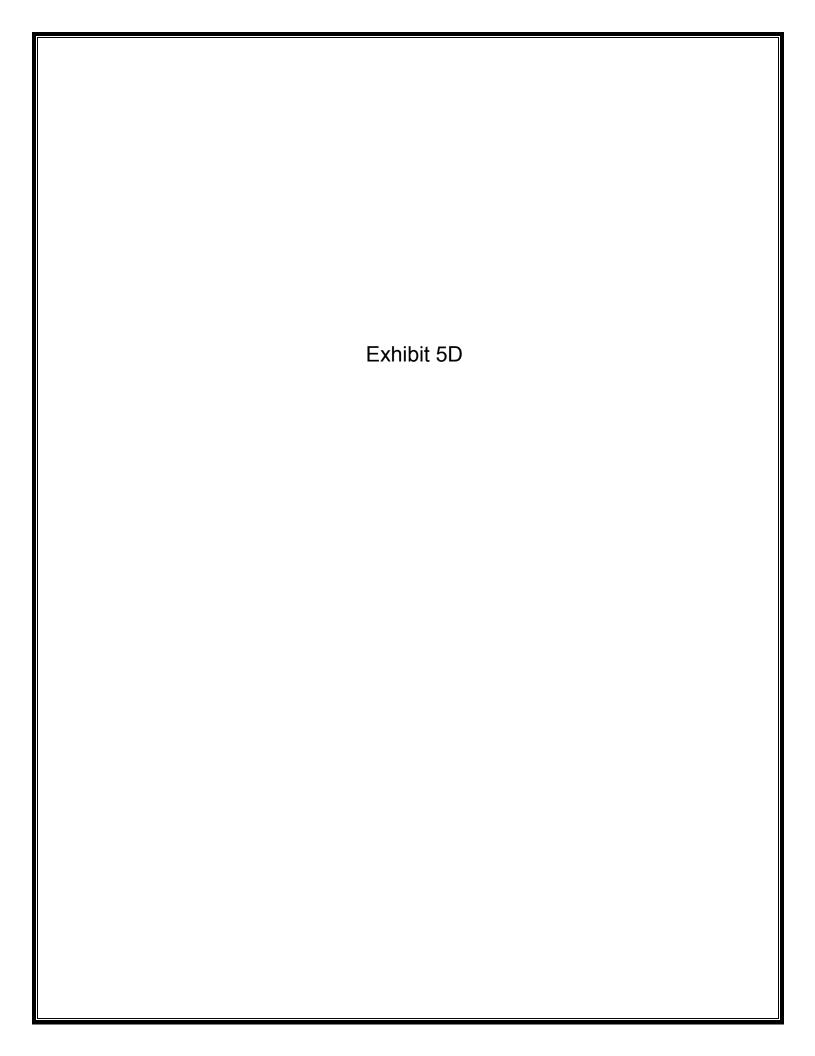
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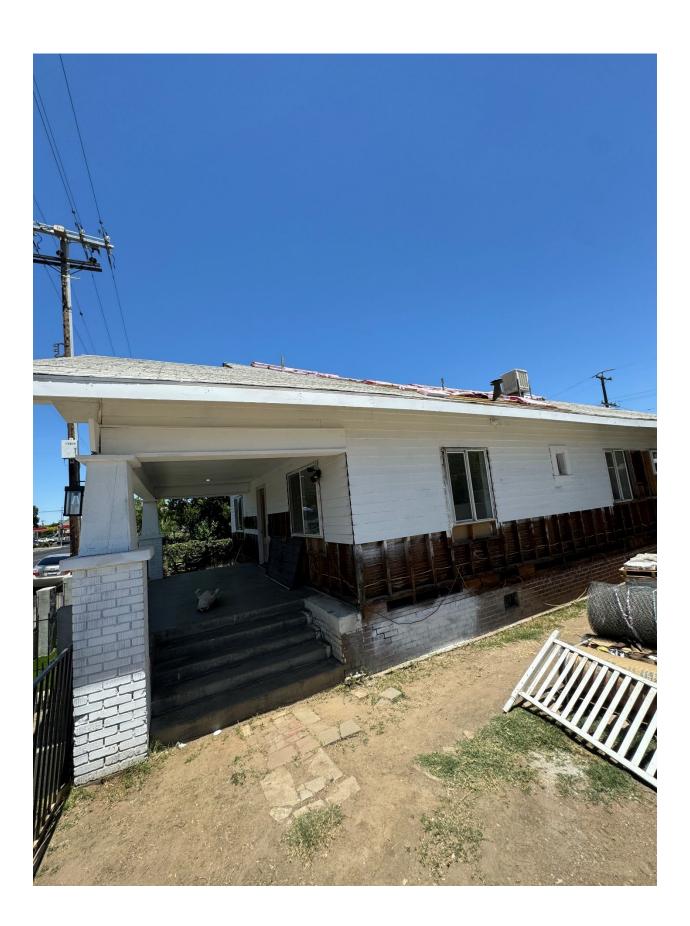
and cann	and cannot be used in whole or part without price			
No.	Description		Date	
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Sign	C - Dimensions 8	Details		
Sheet	Number:			
6				
Appro	oved By:		Date:	
			5-22-24	
















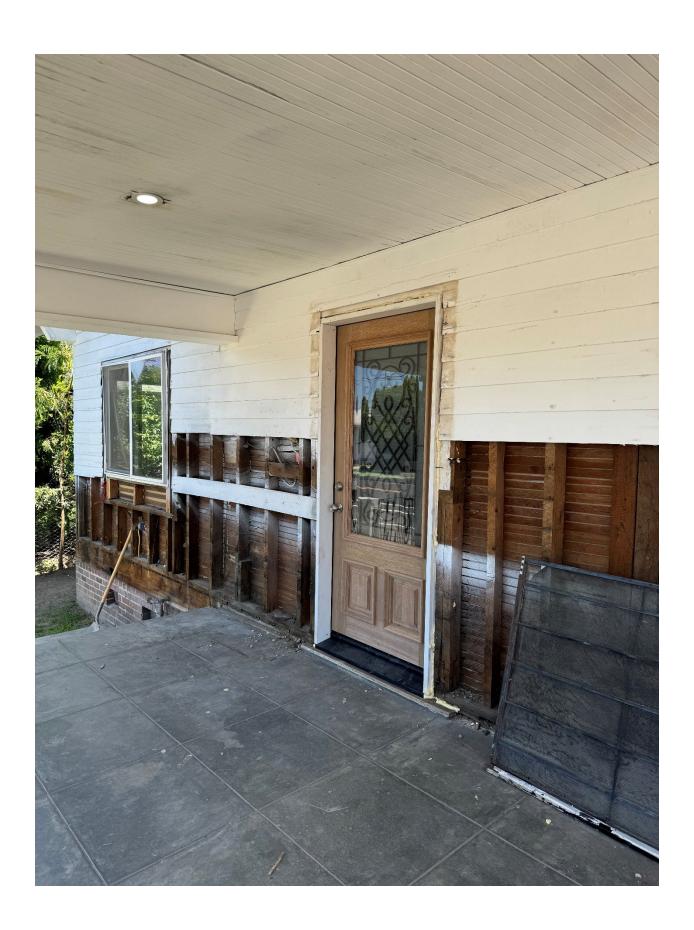

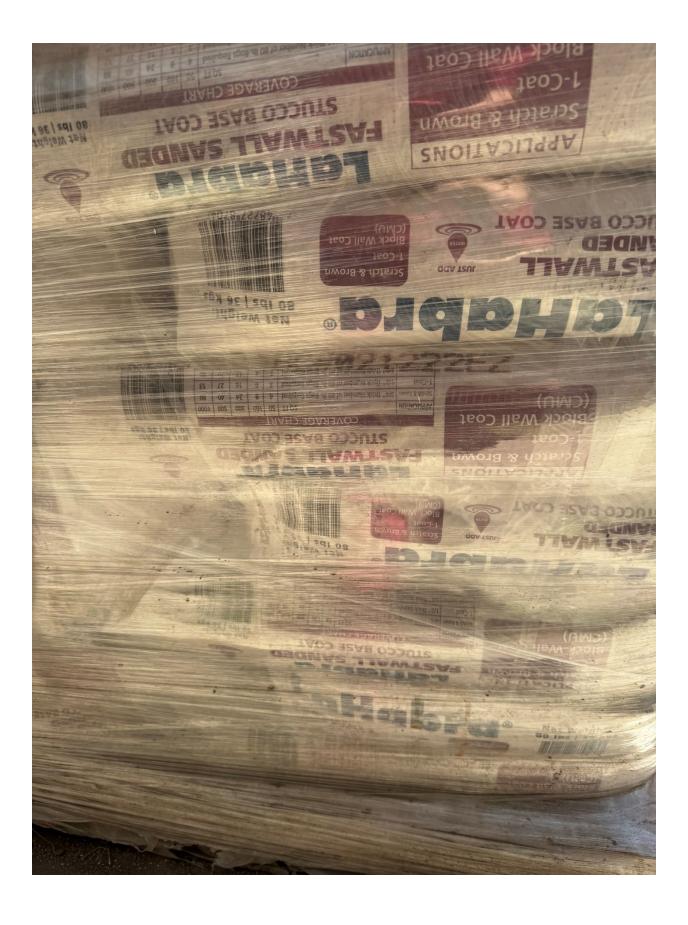

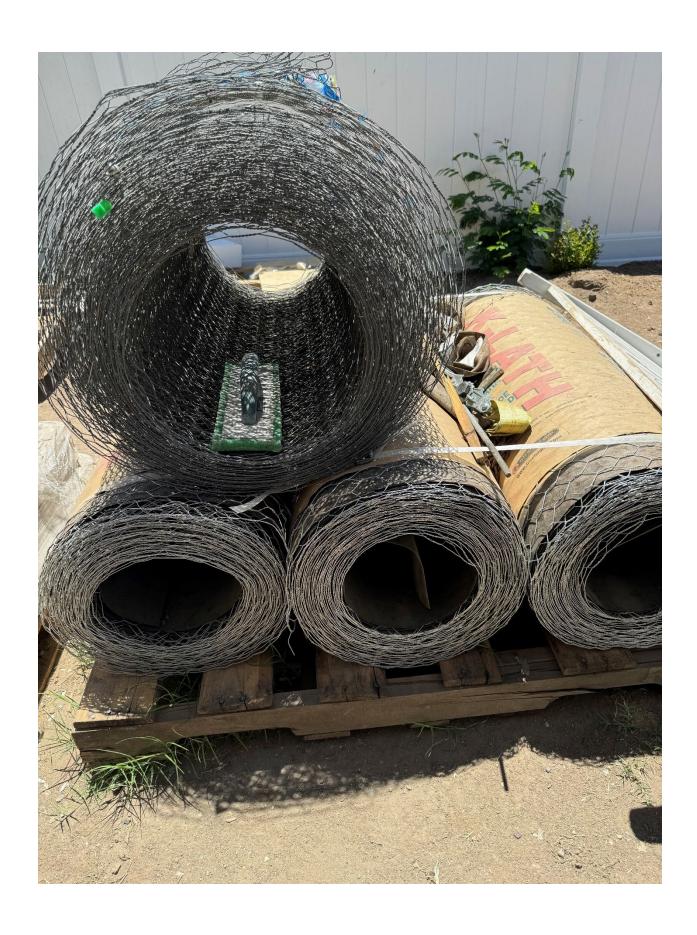

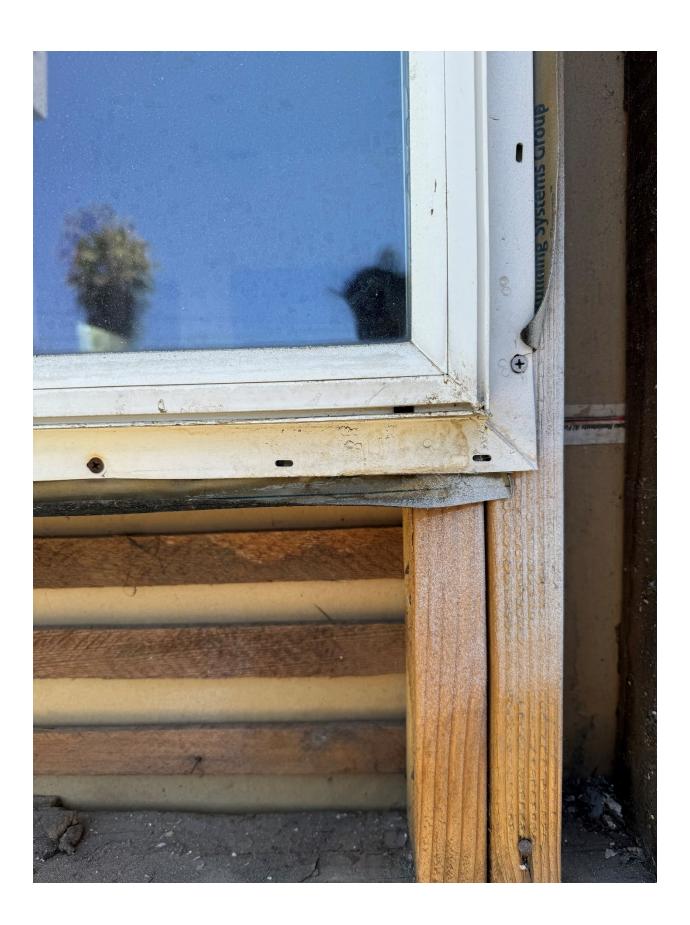

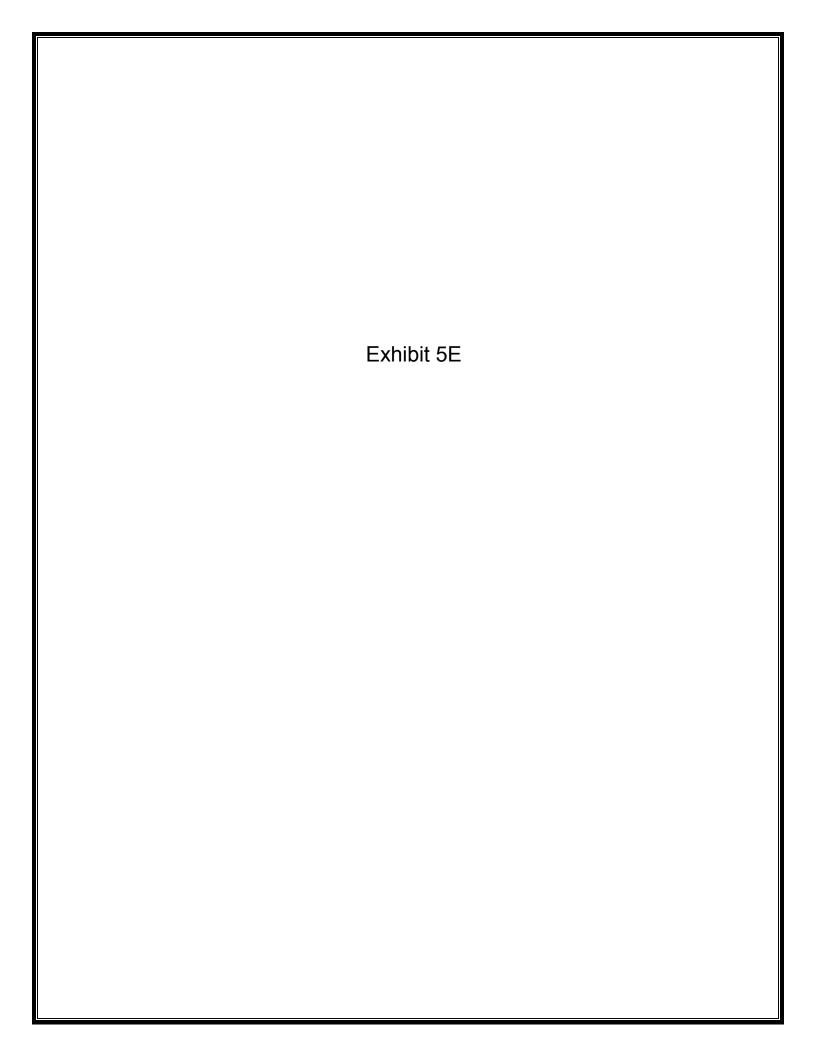



601 E. Olive Avenue - Fresno, California


Exterior Sign Program

November 17, 2023 May 29, 2024 June 14, 2024

				PAGE 1 OF 5
9	7	∞	6	PAG
REVISED	2	3	4	5
you by Fluoresco. It is pressed written approval.	DWG # 11984	DESIGNER	Miguel Reiman	
This original unpublished drawing is submitted for use in connection with a project being designed for you by Fluoresco. It is REVISED not to be shown to anyone outside of your organization, reproduced or used in any fashion without expressed written approval.	PROJECT Noodle Express	LOCATION 601 E. Olive Avenue - Fresno, CA 93728	Scale As Noted SALESPERSON Larry Cooper	Date Nov 17, 2023 FILE NAME Noodle Express2.cdr






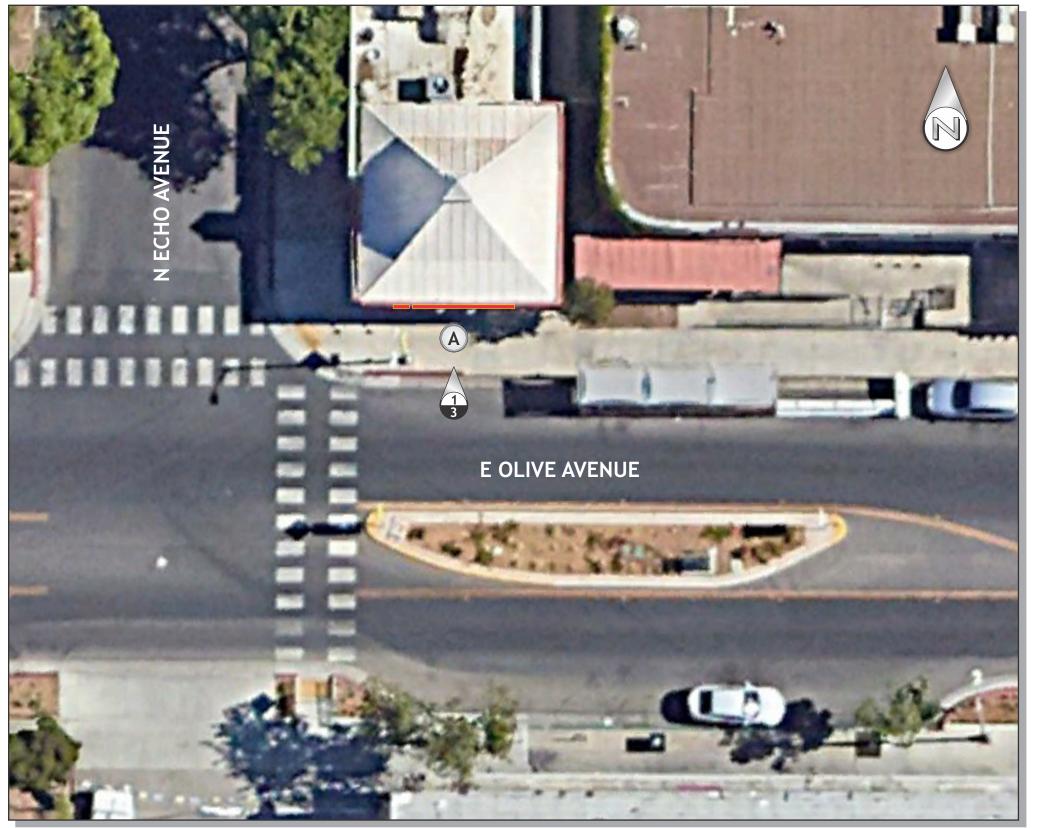

	SCOPE OF WORK						
Sign type	Description	Qty	Page				
	Cover Page		1				
	Table of contents - Site Map		2				
	South Elevation		3				
Α	Internally Illuminated Channel Letters & Logo	1	4				
		<u> </u>					
		_					
		\vdash					
		\vdash					



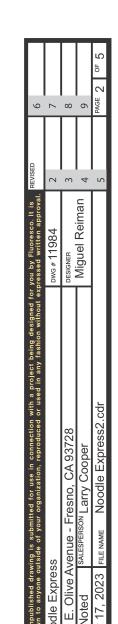







SOUTH ELEVATION

34.00' sq ft

Scale: 1/4" = 1'-0"





18'-6"

HALO ILLUMINATED CHANNEL LETTERS

27.75

One set required Scale: ½" = 1'


1. .080" aluminum letter face painted satin white.

2. 3½" deep .063" aluminum returns painted satin white.


- 3. ¼" thick translucent white acrylic.
- 4. Angle clip with hexagonal screw.
- 5. 1/4" weep hole with light tight baffle.
- 6. 3/16" x 3" long lag bolt (minimum 3 per letter).
- 7. $1\frac{1}{2}$ " x $\frac{3}{8}$ " diameter spacer painted to match finished wall surface.
- 8. 6500K White LED module
- 9. Low voltage secondary power supply
- 10. UL listed LED transformer.
- 11. Ground wire.
- 12. Galvanized vented transformer housing.
- 13. Electrical conduit.
- 14. All building penetrations are to be sealed and watertight via 1/8" bead of SikaFlex 1A elastomeric sealant.
- 15. Emergency disconnect switch in primary electrical circuit.
- 16. Primary electrical circuit.
- 17. Finished building surface.





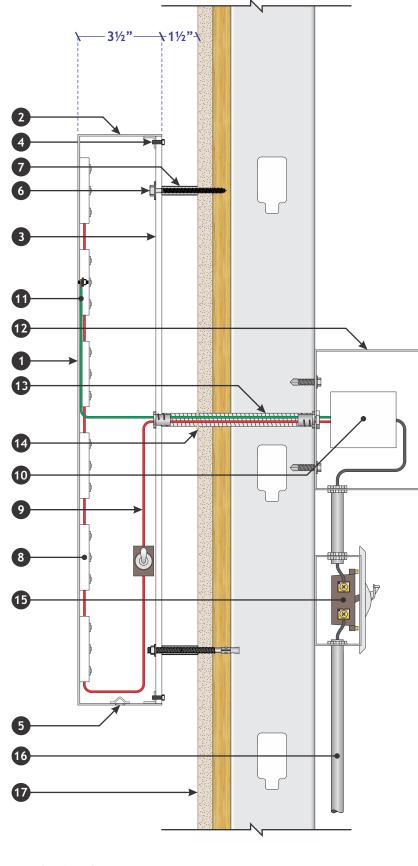



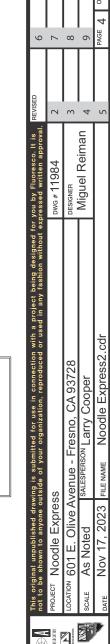











DUAL ILLUMINATED CHANNEL PLAQUE

6.25' I

Scale: 1½" = 1'-0"

One set required

1. .080" aluminum letter face routed for push through copy.

- 2. ¾" thick clear acrylic copy with translucent colored vinyl overlay.
- 3. 3½" deep .063" aluminum returns painted satin white.
- 4. 1/4" thick translucent white acrylic back.
- 5. Angle clip with hexagonal screw.
- 6. ¼" weep hole with light tight baffle.
- 7. 3/16" x 3" long lag bolt (minimum 3 per letter).
- 8. 1½" x ¾" diameter spacer painted to match finished wall surface.
- 9. 6500K White LED module
- 10. Low voltage secondary power supply
- 11. UL listed LED transformer.
- 12. Ground wire.
- 13. Galvanized vented transformer housing.
- 14. Electrical conduit.
- 15. All building penetrations are to be sealed and watertight via 1/8" bead of SikaFlex 1A elastomeric sealant.
- 16. Emergency disconnect switch in primary electrical circuit.
- 17. Primary electrical circuit.
- 18. Finished building surface.

