

Exhibit F Exhibits (Site Plan, Elevations, Floor Plans)

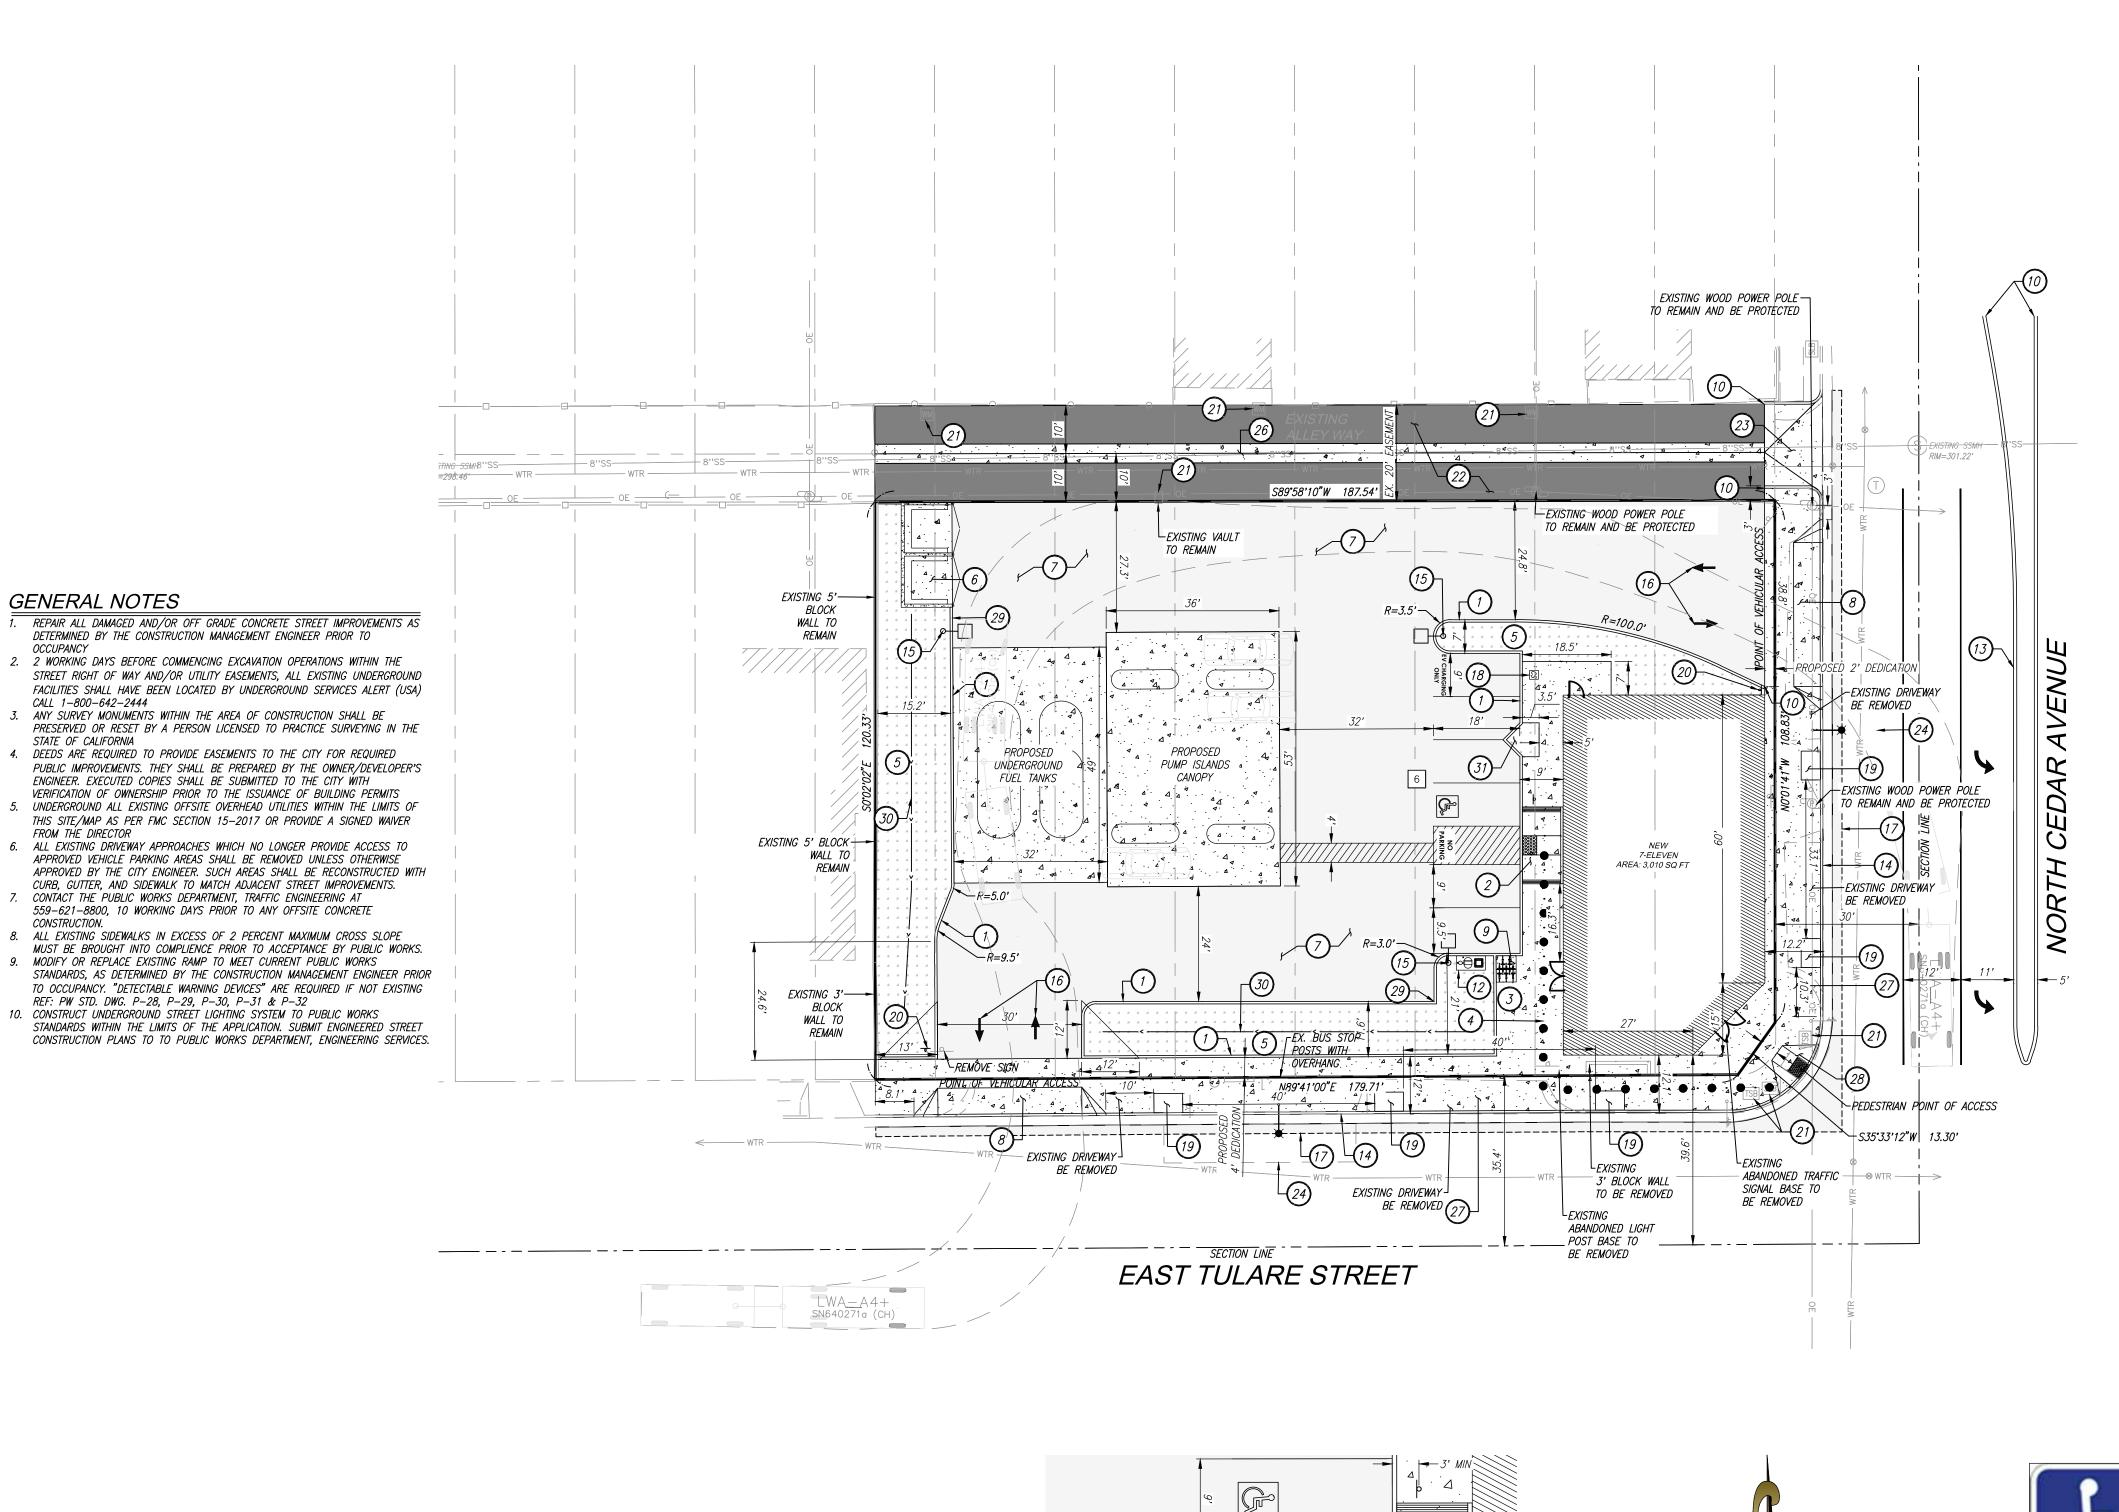

TYPICAL VAN ACCESSIBLE PARKING STALL NOT TO SCALE

NOTE: THE FIRST REQUIRED ACCESSIBLE PARKING SPACE SHALL BE VAN ACCESSIBLE

LEGEND: EXISTING PROPERTY LINE SITE BOUNDARY EXISTING RIGHT OF WAY EXISTING SECTION LINE EXISTING 10" SANITARY SEWER LINE EXISTING 14" WATER MAIN PROPOSED CURB AND GUTTER ● · ● · ● · ● · PROPOSED PATH OF TRAVEL PROPOSED CONCRETE IMPROVEMENT PROPOSED AC PAVEMENT PER P-21, P-22, & P-23 PROPOSED AC PAVEMENT PER P-12 PROPOSED PEDESTRIAN CROSS WALK PROPOSED LANDSCAPE AREA INDICATES NUMBER OF PARKING STALLS

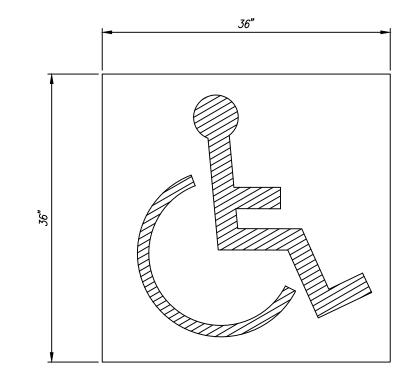

INTERNATIONAL SYMBOL OF ACCESSIBILITY NOT TO SCALE




VAN **ACCESSIBLE**

SCALE 1" = 20'



1. THE CLEAR HEIGHT OF THE LOWEST PORTION OF THE LOWEST SIGN ON THE POLE SHALL BE A MINIMUM OF 80 INCHES ABOVE THE GROUND. 2. THE TOP SIGN SHALL BE REFLECTORIZED AND A MINIMUM OF 24" x 12" AND SHALL CONSIST OF THE INTERNATIONAL SYMBOL OF ACCESSIBILITY IN WHITE ON A DARK BLUE BACKGROUND. 3. THE VAN ACCESSIBLE SPACE SHALL BE THE WESTERN STALL, AS INDICATED ON THE PLAN. 4. THE SIGNAGE SHALL COMPLY WITH ALL REQUIREMENTS SET FORTH IN THE 2013 CBC. SECTION 1129 AND 2012 MUTCD CALIFORNIA SUPPLEMENT.

> SIGN AND SYMBOLS OF ACCESSIBILITY NOT TO SCALE

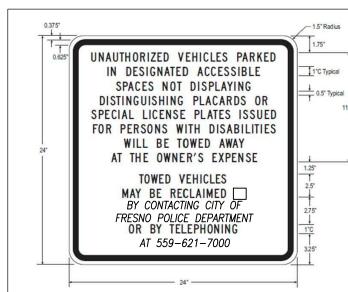

1. THE CLEAR HEIGHT OF THE LOWEST PORTION OF THE SIGN SHALL BE A MINIMUM OF 80 INCHES ABOVE THE GROUND. 2. THE SIGN SHALL NOT BE LESS THAN 24" BY 24" IN SIZE WITH LETTERING NOT LESS THAN 1" IN HEIGHT, WHICH CLEARLY AND CONSPICUOUSLY STATES THE TEXT SHOWN ABOVE. THE SIGN SHALL HAVE A DARK BLUE BACKGROUND WITH WHITE LETTERING. THE BLANK SPACES SHOWN ABOVE ARE TO BE FILLED IN WITH THE APPROPRIATE INFORMATION AS A PERMANENT PART OF THE SIGN.

EXISTING SIGNAGE NOT IN COMPLIANCE WITH THIS DETAIL SHALL BE REPLACED PER THIS 6. THE SIGNAGE SHALL COMPLY WITH ALL REQUIREMENTS SET FORTH IN THE 2013 CBC, SECTION 1129B.4 AND 2012 MUTCD CALIFORNIA SUPPLEMENT.

KEYNOTES

PROPOSED ACCESSIBLE RAMP PER DETAIL THIS SHEET PROPOSED CONCRETE SIDEWALK PER CITY OF FRESNO STD. P-5. PROPOSED DOTTED LINE INDICATES LOCATION OF PATH OF TRAVEL FROM PUBLIC WAY AND/OR ACCESSIBLE STALL SPACES AISLE TO MAIN ENTRANCE

PROPOSED LANDSCAPE AREA

OF TENANT SPACE

PROPOSED TRASH ENCLOSURE PER CITY OF FRESNO STD. P-33 THROUGH

PROPOSED 6" CONCRETE CURB PER CITY OF FRESNO STD. P-5

PROPOSED AC PAVING PER CITY OF FRESNO STD. P-21,P-22, & P-23 PROPOSED 30' DRIVEWAY APPROACH PER CITY OF FRESNO STANDARD P-2, P-6 & P-48. PROVIDE 10' OF RED CURB ON EITHER SIDE OF APPROACH

PROPOSED BICYCLE PARKING

PROPOSED CURB TAPER

PROPOSED HEALY TANK

PROPOSED AIR/WATER STATION

PROPOSED MEDIAN PER CITY OF FRESNO STD. P-62 AND MEDIAN CURB PER CITY OF FRESNO STD. P-9. TO BE SUBMITTED ON STREET PLANS FOR

PROPOSED 6" CONCRETE CURB AND GUTTER PER CITY OF FRESNO STD.

PROPOSED SITE LIGHT

PROPOSED PAINTED DIRECTIONAL ARROWS

PROPOSED LIMIT OF SAWCUT

PROPOSED EV CHARGER

PROPOSED 4'X6' TREE WELL PER CITY OF FRESNO STD. P-8

INSTALL 30" STATE STANDARD "STOP" SIGN AT LOCATION SHOWN. SIGN SHOULD BE MOUNTED ON A 2" GALVANIZED POST WITH THE BOTTOM OF THE LOWEST SIGN 7' ABOVE GROUND, LOCATED BEHIND CURB AND IMMEDIATLY BEHIND MAJOR STREET SIDEWALK. INSTALL RIGHT TURN ONLY SIGN R3-5 (RIGHT) DIRECTLY BELOW

ADJUST UTILITY BOX TO GRADE

STREET LIGHT PLANS FOR REVIEW

CONSTRUCT ALLEY PAVING PER CITY OF FRESNO STD. P-12

CONSTRUCT ALLEY APPROACH PER CITY OF FRESNO STD. P-13 PROPOSED STREET LIGHT WITH METAL POLE PER E-1. TO BE SUBMITTED ON

PROPOSED CURB RAMP PER CITY OF FRESNO STD. P-31 AND P-32

CONSTRUCT CONCRETE VALLEY GUTTER PER CITY OF FRESNO STD. P-10

PROPOSED 12' SIDEWALK PER CITY OF FRESNO STD. P-5

PROPOSED CURB RAMP PER CITY OF FRESNO STD. P-31 AND P-32

PROPOSED CURB CUT

PROPOSED SWALE

PROPOSED TREE WELL

ACCESSIBLE ENTRY SIGN NOT TO SCALE

SHEET NUMBER: 2 OF 2


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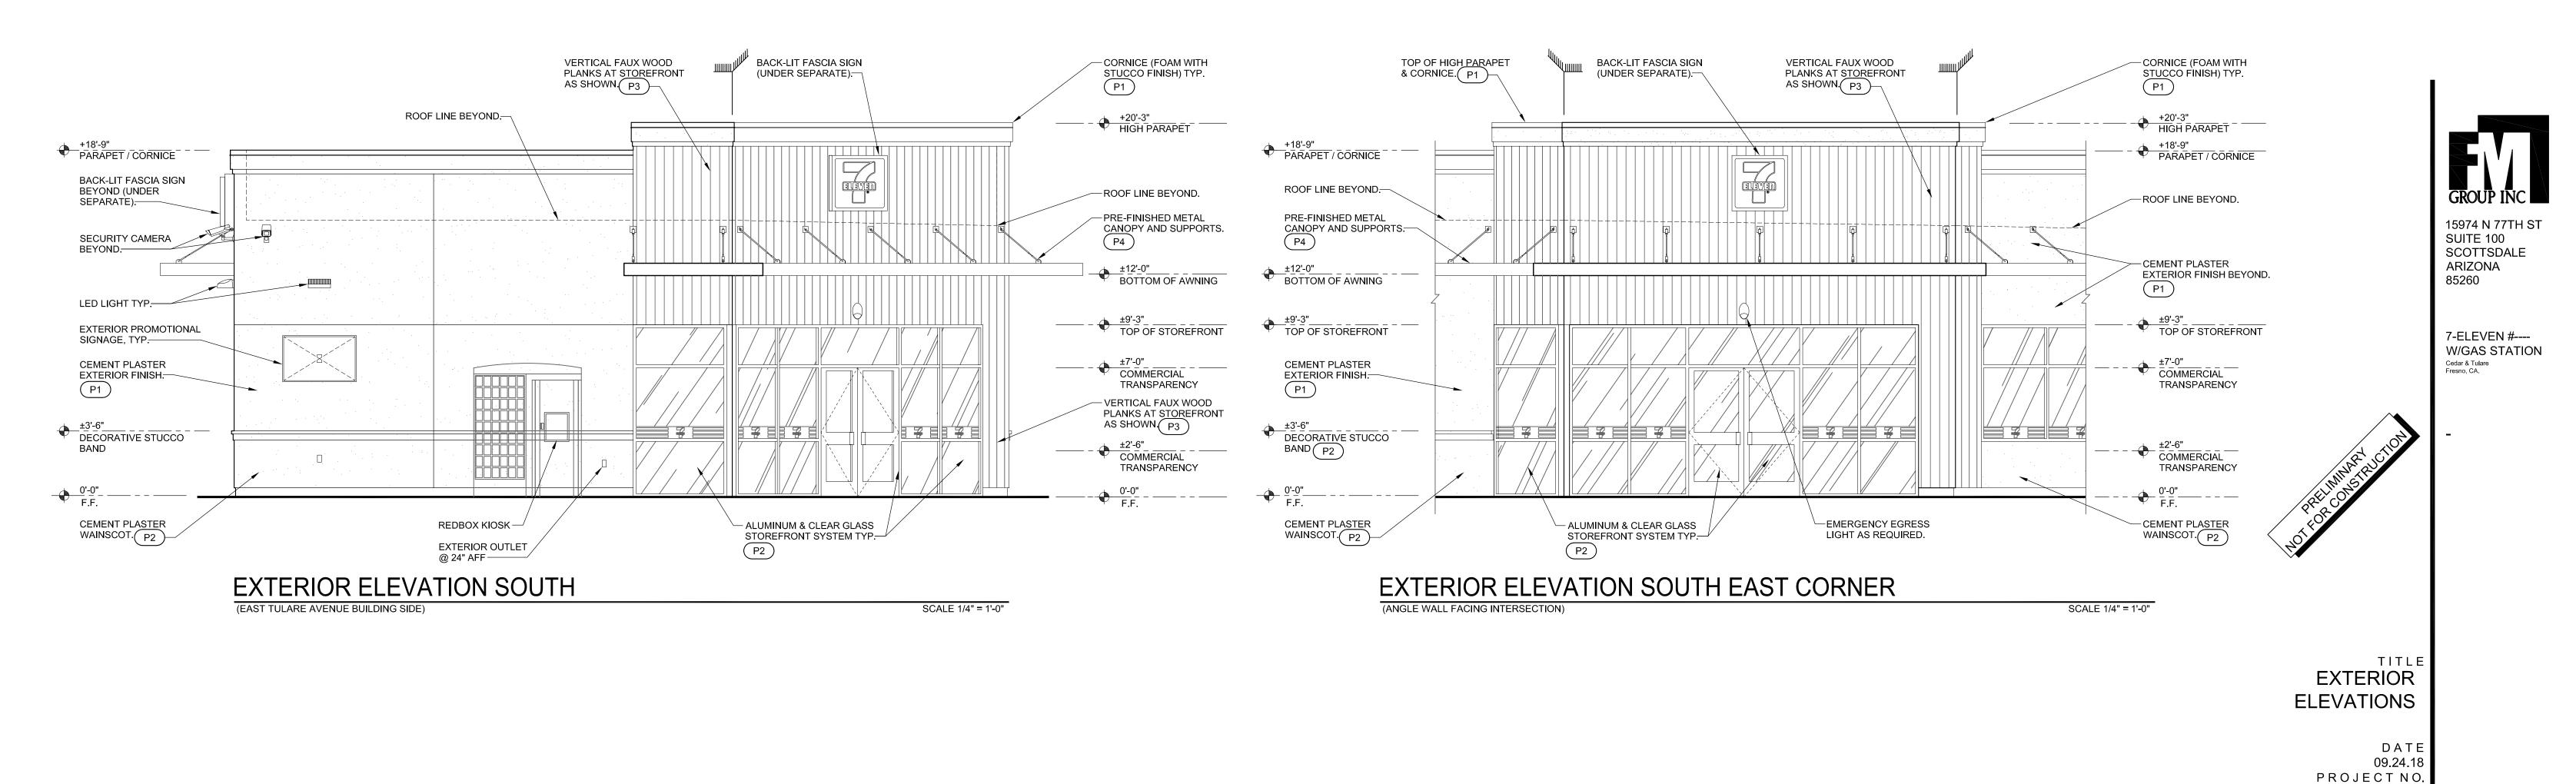
REVISIONS

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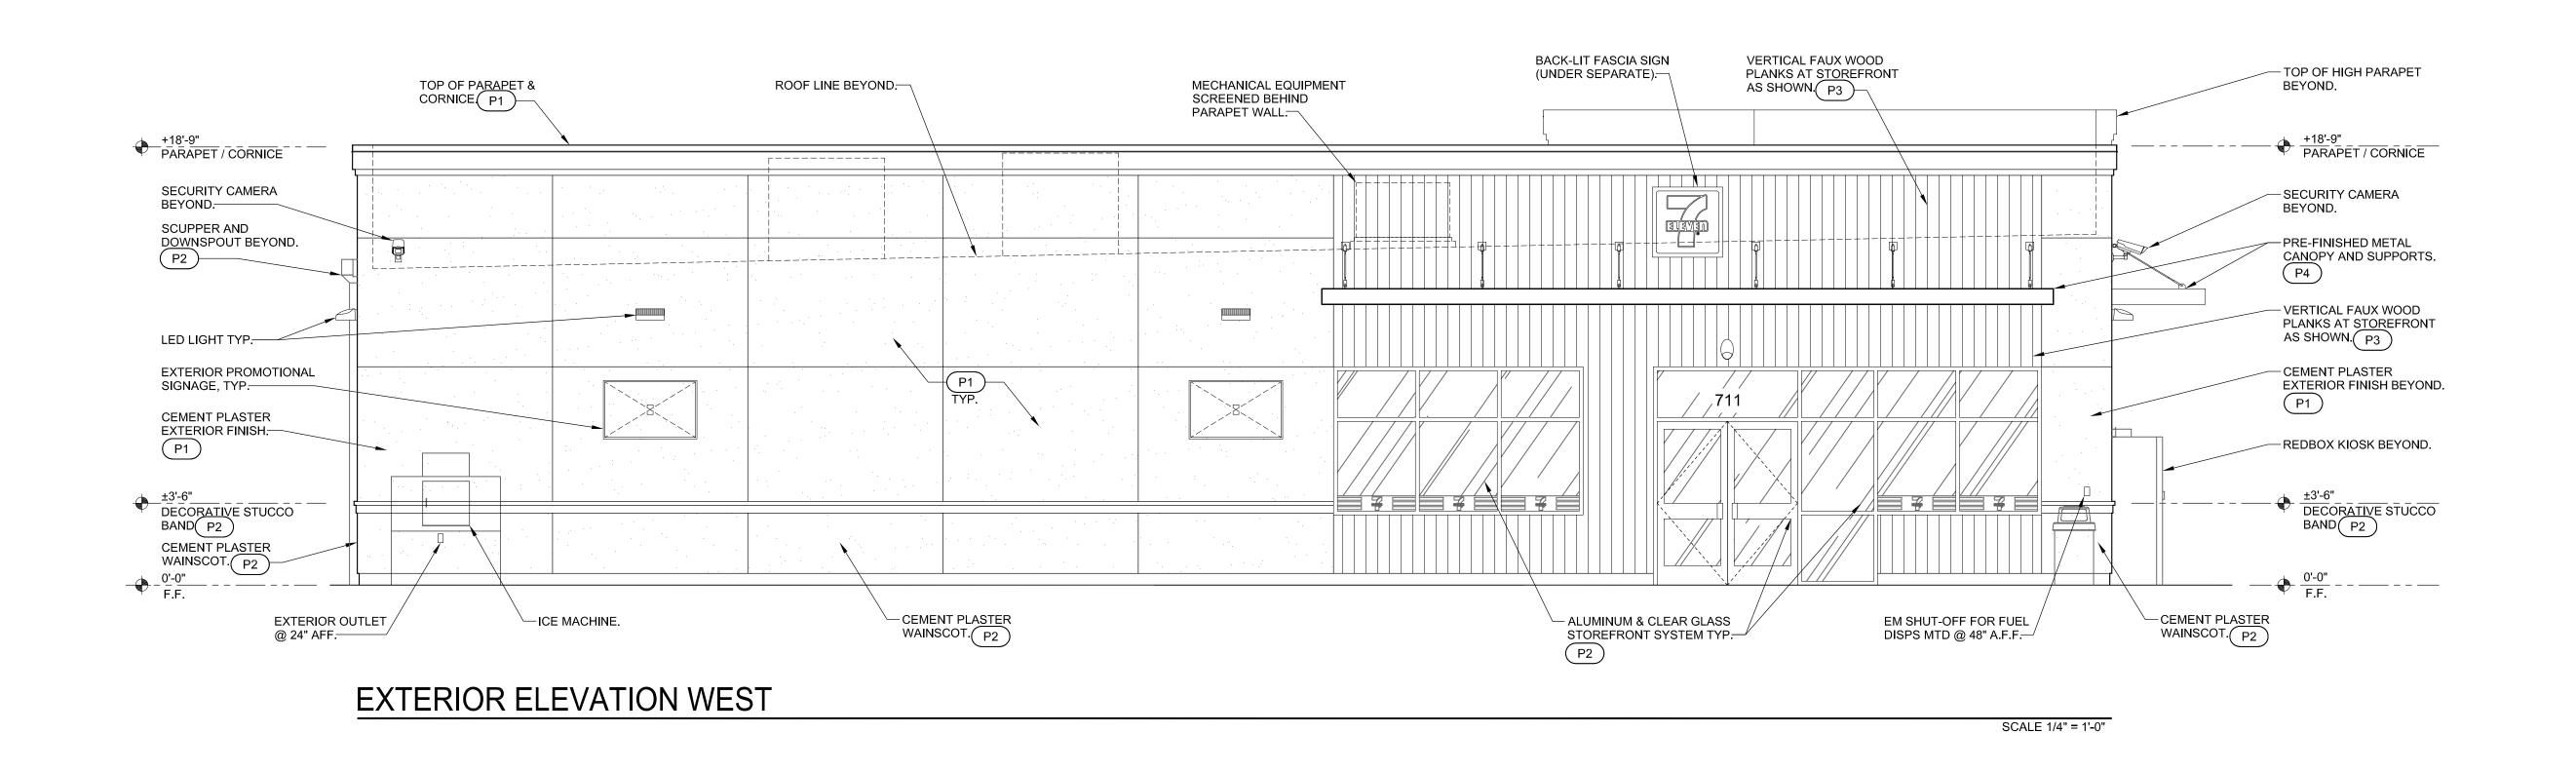
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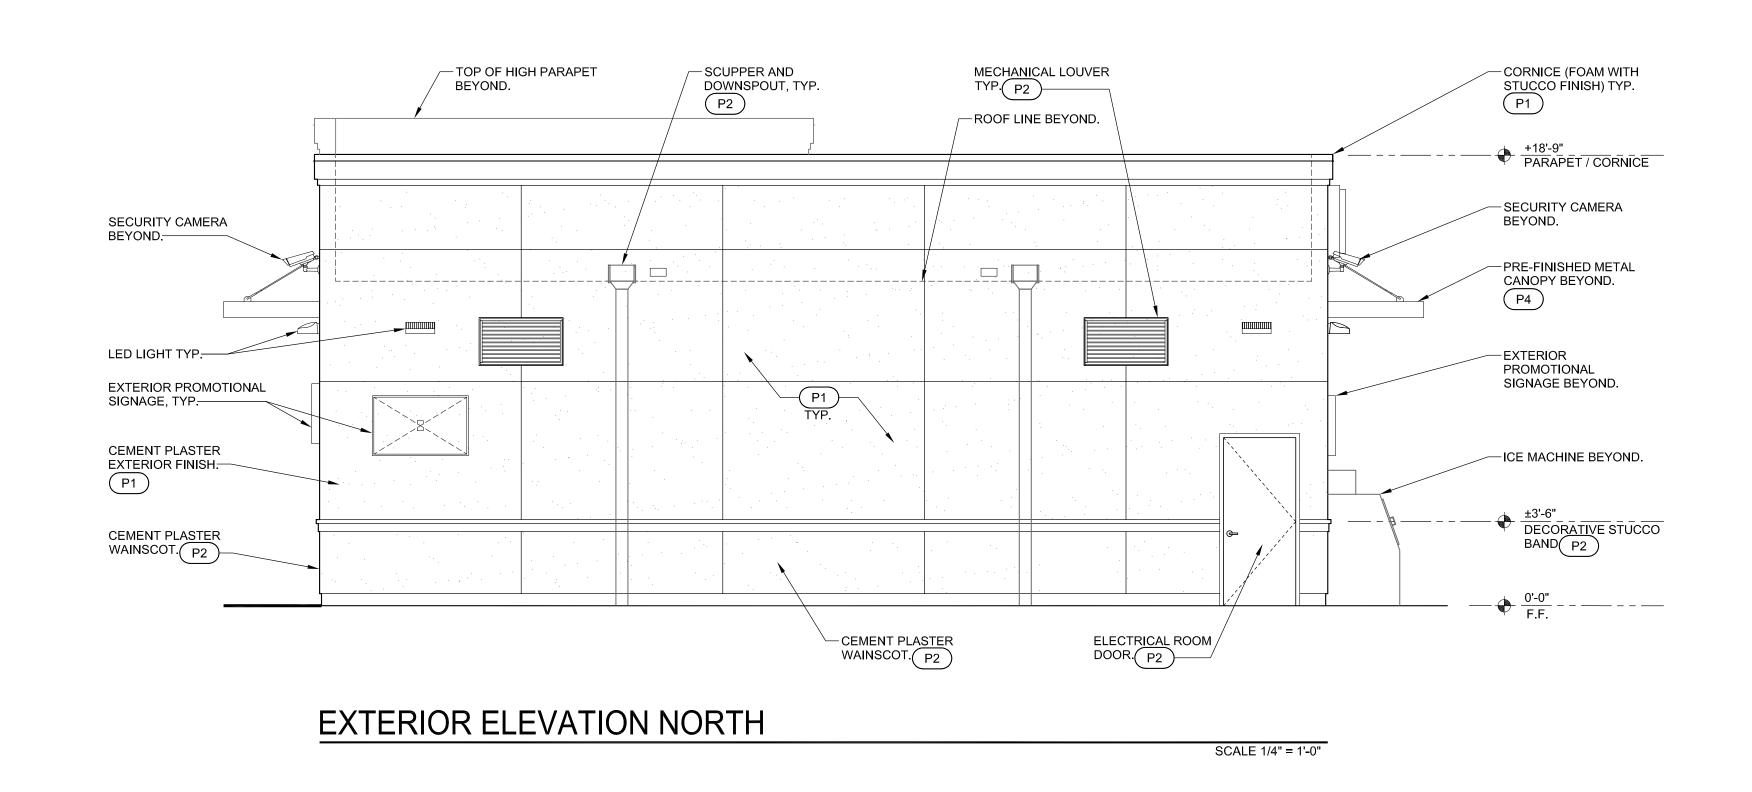
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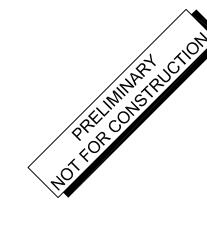
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7-ELEVEN #----W/GAS STATION Cedar & Tulare Fresno, CA.



EXTERIOR ELEVATIONS

> DATE 09.24.18 PROJECT NO.
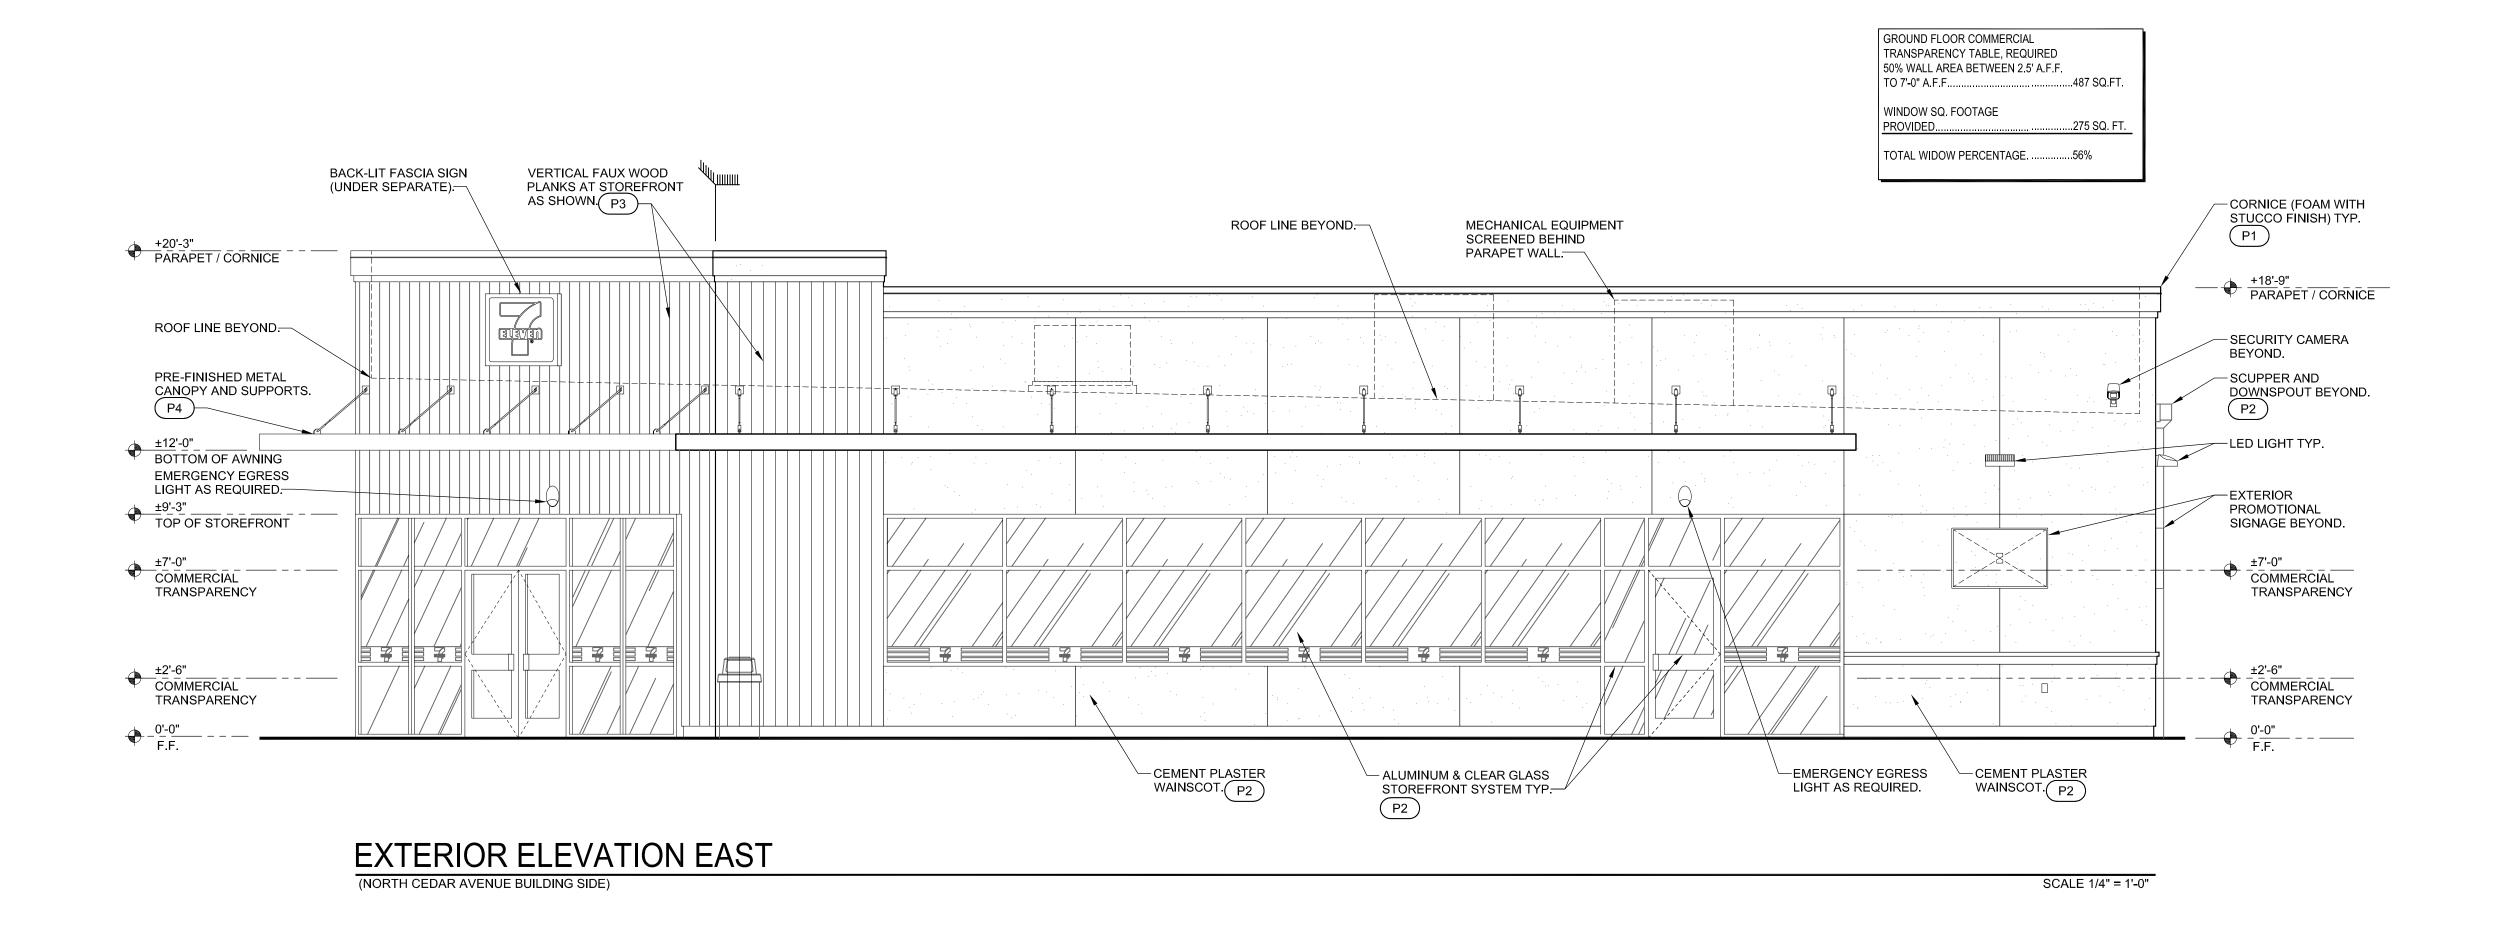
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LAYOUT INFORMATION

ROLLER GRILLS 2 (SELF SERVE) SANDWICH CASE VAULT DOORS **LOW TEMP DOORS** ICE MERCH. DOORS **NOVELTY CASE** BAKERY CASE 1 (LG) SLURPEE BARRELS

20 06 GONDOLA UNITS (60"H)

END CAPS (60"H) POWER WINGS (12) - NOT IN TOTAL LOW WALLS (36"H)

HIGH WALLS (72"H) <u>00</u> 29 TOTAL

TOTAL SQ FT = 3,202 SFSALES FLOOR AREA = 2,114 SF

LIQUOR: NO GAS: YES BEER: YES WINE: YES

OCCUPANCY LOAD (>49) = 68 TRAVEL DISTANCE (<200) = 100' COMMON PATH OF TRAVEL (<75) = 40' RESTROOMS REQUIRED = 2 **EXITS REQUIRED**

OVERHEAD SHELVES = 38 FT = 35 FT FLOOR SHELVES

WALL TYPE LEGEND

EXISTING WALL

EXISTING COLUMN

NEW WALL


NEW PARTIAL HEIGHT WALL

NEW COOLER WALL

OCCUPANCY CALCULATION MERCHANDISE KITCHEN / SALES STORAGE/ BACK ROOM OFFICE RESTROOM

62 PEOPLE 1835 SF 279 SF 2 PEOPLE 3 PEOPLE 840 SF 300 = 48 SF 100 = 1 PERSON 200 SF N/A = 0 PEOPLE

> TOTAL 68 PEOPLE

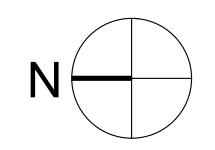


1042810 - FRESNO, CA - LAYOUT 5

11/12/18

SCALE: 1/4"=1'-0" 4151 E. TULARE FRESNO, CA

APPROVED: YES 00/00/00

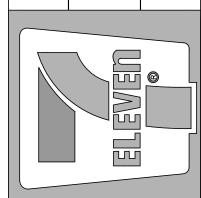



2018111.33	AS NOTED	11/12/18	ТВ	ЬО
JOD#. ZU	Scale: AS	Date:	Drawn By:	Checked By: PO



SHEET NUMBER: 1 OF 1

JOB NUMBER:

SOIL REPORT NOTES SHALL REFER TO THE SUNSET WESTERN GARDEN BOOK FOR COMPLETE DESCRIPTIONS OF PLANT MATERIALS. SUBSTITUTIONS OF PLANT AFTER THE SITE HAS BEEN CLEARED OF DEBRIS AND PRIOR TO CONSTRUCTION
BEGINNING, A SOILS SAMPLE IS TO BE
OBTAINED TO DETERMINE SOIL
FERTILITY. THE SOIL SAMPLE IS TO BE
OBTAINED PER THE RECOMMENDATIONS WITHOUT PRIOR AUTHORIZATION BY THE CITY OF FRESNO AND/OR

OF THE SOIL TESTING LABORATORY. THE SOIL FERTILITY RESULTS ARE TO BE MADE AVAILABLE TO THE LANDSCAPE CONTRACTOR PRIOR TO WORK BEGINNING. UPON COMPLETION OF CONSTRUCTION AND PRIOR TO ISSUANCE OF AN OCCUPANCY PERMIT OR PROJECT ACCEPTANCE, THE PROJECT APPLICANT OR DESIGNEE
SHALL SUBMIT DOCUMENTATION SOIL ANALYSIS REPORT RECOMMENDATIONS WITHIN THE LANDSCAPED AREA TO THE CITY WITH THE CERTIFICATE OF COMPLETION.

PLANTING NOTES

1.THE CONTRACTOR SHALL BE RESPONSIBLE FOR PROVIDING ALL WORK, MATERIALS, EQUIPMENT AND SERVICES FOR PERFORMING THE "PLANTING" APPEARING ON THE CONSTRUCTION DRAWINGS FOR THE INSTALLATION OF THIS PROJECT. PROCEED WITH CONSTRUCTION AS DESIGNED WHEN IT IS OBVIOUS THAT UNKNOWN OBSTRUCTIONS AND/OR COST TO THE OWNER.

GRADE DIFFERENCES EXIST THAT MAY 7.CONTRACTOR SHALL NOTIFY OWNER'S
AUTHORIZED REPRESENTATIVE 48 DESIGN. SUCH CONDITIONS SHALL BE IMMEDIATELY BROUGHT TO THE ATTENTION OF CLIENT

REPRESENTATIVE. THE CONTRACTOR
SHALL ASSUME FULL RESPONSIBILITY
FOR ALL NECESSARY REVISIONS DUE

OBSERVATION SCHEDULES.

8.NO PLANTING WORK SHALL BEGIN
UNTIL THE FOLLOWING HAS BEEN
COMPLETED AND APPROVED BY THE TO FAILURE TO GIVE SUCH NOTIFICATION. 3.CONTRACTOR SHALL BE RESPONSIBLE FOR ANY COORDINATION WITH SUBCONTRACTORS AS REQUIRED TO ACCOMPLISH PLANTING OPERATIONS. FOR PLANTING REQUIREMENTS. MATERIALS AND EXECUTION, STAKING METHOD, PLANT PIT DIMENSIONS REQUIREMENTS. 5.THE CONTRACTOR SHALL REFER TO THE PLANS AND SPECIFICATIONS WHEN PREPARING THE BID. THE CONTRACTOR SHALL VERIFY THE AVAILABILITY OF THE PLANT MATERIAL IMMEDIATELY AFTER THE SIGNING OF THE CONTRACT WITH THE OWNER.

PLANTS SHALL BE TRUE TO THE BOTANICAL NAME; GENUS, SPECIES

LEGEND:

0.25 GPM (FIXED RATE) FLOOD BUBBLER

1/2" CUT-OFF NIPPLE (LENGTH AS REQUIRED)

LATERAL LINE & FITTING —

SHRUB PLANTING

1/2" SCH 40 POLY STREET ELL MPTxFPT ___

1/2" SCH 40 PVC ELL TxT

AND/OR HYBRID NAME AS SPECIFIED

IN THE PLANT LEGEND. CONTRACTOR

LANDSCAPE ARCHITECT. ALL SUBSTITUTIONS SHALL BE SUBMITTED IN WRITTEN FORM. CONTRACTOR SHALL CONTACT CLIENT'S REPRESENTATIVE IMMEDIATELY WITH ANY DISCREPANCY OR UNAVAILABILITY ISSUES. FAILURE TO MAKE SUCH CONFLICTS KNOWN TO CLIENT'S REPRESENTATIVE WILL RESULT IN THE CONTRACTOR'S RESPONSIBILITY TO COVER REPLACEMENT, ETC.
13. LANDSCAPE AREAS TO BE ROUGH REPLACE THE INAPPROPRIATE MATERIALS AT NO EXPENSE TO GRADED TO 4" BELOW SURROUNDING 6.ALL PLANT MATERIAL MUST BE APPROVED BY THE OWNER'S HARDSCAPE FINISHED SURFACE TO ALLOW FOR 3" MULCH LAYER.

AUTHORIZED REPRESENTATIVE 14. THE CONTRACTOR SHALL USE THE FOLLOWING PROCEDURES TO AND/OR LANDSCAPE ARCHITECT PRIOR TO INSTALLATION. PLANTS
SHALL BE OF ADEQUATE SIZE AS
SPECIFIED ON THE PLANS AND BE IN CONTAINER BACKFILL METHOD
GOOD CONDITION UPON ARRIVAL AT
THE PROJECT SITE. THEY SHALL BE
FREE OF BROKEN LIMBS, CUTS OR
TOGETHER ON-SITE. USE THIS ABRASIONS TO IT'S TRUNK AND LIMBS, SUN SCALDED LEAVES, INSECT CONTAINER PLANTINGS. TO ONE CUBIC YARD ON SITE SOIL, ADD THE FOLLOWING: INFESTATIONS, DISEASES, FUNGI AND SHOW NO SIGNS OF DISTRESS FROM LACK OF WATERING. ALL
SUBSTANDARD PLANT MATERIAL WILL *8 CU. FEET - KELLOGG'S 'NITRO-HUMUS' OR EQUAL BE REPLACED AT NO ADDITIONAL COST TO THE OWNER. SOIL OPTIMIZER, WITH 14% HUMIC HOURS PRIOR TO COMMENCEMENT OF WORK TO COORDINATE PROJECT OBSERVATION SCHEDULES. COMPLETED AND APPROVED BY THE OWNER'S REPRESENTATIVE AND/OR HE CITY OF FRESNO: DRAINAGE

SYSTEM, IRRIGATION SYSTEM, FINAL GRADES HAVE BEEN ESTABLISHED,

SOIL PREPARATION AND PLANTING AREAS HAVE BEEN PROPERLY

GRADED. 9.FINAL LOCATION OF ALL PLANT

MATERIALS SHALL BE SUBJECT T THE APPROVAL OF THE OWNER'S

AREAS AND PLANS, CONTRACTOR SHALL CONTACT THE CLIENT'S

REPRESENTATIVE FOR RESOLUTION

5. PRIOR TO TOP DRESSING, USE PRE-EMERGENT HERBICIDE, 'RONSTAR" OR EQUAL AT A RATE SPECIFIED BY THE MANUFACTURER FOR ALL SHRUB PLANTING AREAS. AVOID PRE-EMERGENT HERBICIDE IN TURF AND ANNUAL COLOR AREAS. 16. THE CONTRACTOR SHALL GUARANTEE THE PLANTING AND ALL OF ITS COMPONENTS FOR THE TIME AUTHORIZED REPRESENTATIVE. IF CONFLICTS ARISE BETWEEN SIZE OF PERIOD SPECIFIED IN THE CONTRACT.
THE GUARANTEE SHALL BEGIN AFTER THE DATE OF FINAL ACCEPTANCE BY
THE OWNER'S REPRESENTATIVE FAILURE TO MAKE SUCH CONFLICTS
KNOWN TO PRECISION CIVIL
ENGINEERING WILL RESULT IN
CONTRACTORS RESPONSIBILITY TO
RELOCATE THE MATERIALS AT NO
EXPENSE TO OWNER. AND/OR THE CITY OF FRESNO. THE CONTRACTOR SHALL BE RESPONSIBLE FOR ALL MATERIALS AND LABOR ASSOCIATED WITH THE GUARANTEE DURING THAT TIME PERIOD. 17. CONTROLLED RELEASE FERTILIZE TABLETS TO BE ADDED PER 10. ALL EXISTING TREES TO REMAIN
SHALL BE PROTECTED FROM DAMAGE
DUE TO CONSTRUCTION. PROVIDE

RECOMMENDATIONS SEE

STANDARD PLANTING DETAIL.

PREPARE BACKFILL PLANTING SOIL:

MIX THE FOLLOWING MATERIALS TOGETHER ON-SITE. USE THIS AS BACKFILL MIX FOR ALL

COMPOSTED MATERIAL

*3 POUNDS - 'JOHN & BOBS'

*INSTALL AGRIFORM 'SLOW RELEASE' 20-10-5 FERTILIZER PELLETS AS PER

CONSTRUCTION.

PROTECTIVE BARRIER THROUGHOUT 18. PRIOR TO BUILDING FINAL (OR FINAL ACCEPTANCE OF THE TRACT), THE CONTRACTOR SHALL BF ALL DOCUMENTS REQUIRED BY MWELO RESPONSIBLE FOR INSTALLING SHALL BE SUBMITTED IN AN REQUIRED ROOT BARRIERS WHEN
TREES ARE FIVE FEET OR LESS FROM ENGINEERING DIVISION: HARDSCAPE AREAS.
12. THE CONTRACTOR SHALL BE IRRIGATION SCHEDULING PARAMETERS USED TO SET THE RESPONSIBLE FOR REPLACEMENT AND CONTROLLER• LANDSCAPE AND IRRIGATION RECONDITIONING THE EXISTING MAINTENANCE SCHEDULE
• IRRIGATION AUDIT REPORT CONSTRUCTION CONTRACT REPLACEMENT AND RECONDITIONING WILL INCLUDE BUT NOT BE NECESSARILY LIMITED TO: RIPPING, SOIL ANALYSIS REPORT
 DOCUMENTATION VERIFYING SOIL PREPARATION, SOIL CONDITIONING, FINE GRADING AND


IMPLEMENTATION OF SOIL ANALYSIS REPORT RECOMMENDATIONS AS-BUILTS OF THE LANDSCAPE SEEDING); TREE, SHRUB AND GROUND PLANTING AND IRRIGATION PLANS WHICH SHALL BE SUBMITTED THROUGH THE ENGINEER OF RECORD, AND NOT THE LANDSCAPE CONTRACTOR, OR WRITTEN CERTIFICATION BY THE ARCHITECT/CONTRACTOR THAT
THE PROJECT HAS BEEN INSTALLED PER PLAN.

NOT TO SCALE NOT TO SCALE

3" HIGH RESERVIOR, BERM REMOVE AT END OF MAINTENANCE NOT TO SCALE FINISH GRADE FERTILIZER TABLETS BACKFILL MIX 100% NATIVE SOIL

> DEEP WATERING ASSEMBLY (2 PER TREE) TREE TRUNK FIGURE EIGHT CINCH TIE, DOUBLE WRAP AT STAKE, PULL TIGHT TO PREVENT SLIPPING 3 INCH HIGH BERM NOT TO SCALE

TREE IRRIGATION WELL

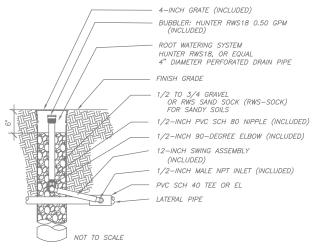

PLANT LEGEND CONTRACTOR SHALL VERIFY ALL PLANT QUANTITIES. COMMENTS WUCOLS VALUE SCIENTIFIC NAME SYMBOL SIZE QTY COMMON NAME TREES SHALL BE PLANTED AS PER CITY OF FRESNO STANDARD TREE ROOT BARRIERS SHALL BE INSTALLED AS PER CITY OF FRESNO STANDARD 15 GAL 2 PISTACHE X 'KEITH DAVEY"/ HYBRID PISTACHE STANDARD LOW ZELKOVA SERRATA 'VILLAGE GREEN' / JAPANESE ZELKOVA STANDARD 1EL 15 GAL LOW SHRUBS SHRUBS SHALL BE PLANTED AS PER CITY OF FRESNO STANDARD **(4)** 1 GAL 43 HESPERALOE PARVIFLORA / BRAKELIGHTS RED YUCCA **(** LOW 5 GAL 82 ROSA 'FLOWER CARPET RED' LOW 1 GAL 30 LIGUSTRUM 'TEXANUM' / WAXLEAF PRIVET 5 GAL ROMNEYA COULTERI / MATILIJA POPPY LOW GROUND COVER 3 INCHES ± OF MULCH IN ALL PLANTERS — WALK—ON DECO BARK 1000 CF± | * +

L-----

EAST TULARE AVENUE

CITY OF FRESNO

AREA: 3,150 SQ FT

TREE, LANDSCAPE & SHADE REQUIREMENTS

(A) PROVIDE ONE MEDIUM SIZE TREE FOR EVERY TWO PARKING

SPACES PROVIDED: 6 TREES REQUIRED: 3 TREES PROVIDED: 9

(B) DISPERSE TREES OVER THE PARKING LOT AREA TO PROVIDE 50 PERCENT SHADING OF THE PARKING AREA SURFACE WITHIN 15 YEARS.

SCALE 1" = 20'

PARKING LOT / PAVED AREA = 10.453 SQ FT 50% SHADE REQUIRED = 5,226 SQ FT

9 ZELKOVA 40' DIA. = 1,257 SF EA. OVERHEAD SHADED AREA OVER PAVING ONLY = 3,828 SF I CANOPY STRUCTURE = 1,908 SF

TOTAL AREA SHADED = 5,736 SF PERCENT SHADE COVERAGE PROVIDED = 55%

(C) A MINIMUM OF (1) TREE FOR EVERY 2,000 SQ FT OF LOT COVERAGE

PROJECT SITE LOT AREA = 21,796 SQ FT ONE TREE PER 2,000 SQ. FT. = 11 TREES

TREES PROVIDED = 9 TREES

(D) A MINIMUM OF 10 PERCENT OF ANY PARKING LOT AREA SHALL BE LANDSCAPED

PARKING LOT AREA = 10,313 SQ FT 10% LANDSCAPED REQUIRED = 1,031 SQ FT

PROPOSED LANDSCAPED AREA = 3,010 SQ FT = 29% LANDSCAPED

1" MULCH LAYER/ KEEP CLEAR OF TRUNK

TREE PLANTING AND IRRIGATION

TREE DEEP WATERING