




	SITE DATA	
	APPLICANT:OMAR YANEZ 1611 W. WRENWOOD AVENUE TEL. NO. (559) 824-6048ADDRESS:7236 N. COLLEGE AVE. FRESNO, CA 93650APN:303-082-37ZONING:RS-5EXISTING USE:VACANT LANDOCCUPANCY:R-2	OUP evelopment Fresno, CA. 93726 one: (559) 289.2192
CRIPTION : & 5 IN BLOCK 21 OF THE TOWNSITE OF PINEDALE IN F FRESNO, COUNTY OF FRESNO, STATE OF AS PER MAP RECORDED IN BOOK 9, PAGES 92 AND S, IN THE OFFICE OF THE COUNTY RECORDER OF TY. CRAL NOTES OF THIS SPECIAL PERMIT MAY BECOME NULL AND EVENT THAT DEVELOPMENT IS NOT COMPLETED IN	LOT AREA : 13,600 SQ. FT. BUILDING AREA : 910 SQFT. / UNIT X 4 = 3,640 SQFT. BUILDING / LOT COVERAGE : 26% OF SITE TOTAL OPEN SPACE : 5,000 SQ. FT. (36%) LANDSCAPE AREA : 4,737 SQFT. PAVED AREA (DRIVEWAYS) : 3,694 SQFT. (SIDEWALKS) : 1,363 SQFT. PARKING SPACES : (1 : 1.25 RATIO) REQUIRED : 5 STALLS PROPOSED : 4 STALLS (COVERED PARKING) 1 ACCESSIBLE PARKING BIKE PARKING PROPOSED : 4 KEYNOTES 1. INSTALL PAVEMENT PER CITY OF FRESNO PW STD. P-21, 22 AND 23 2. COVERED PARKING STALL	C+E Design Grou Design, Planning & Devel Design, Planning & Devel 4021 N. Fresno Street, ste #103 Fre Phone: (559) 360.7143 Phone:
2E WITH ALL THE CONDITIONS AND REQUIREMENTS I THIS SPECIAL PERMIT, THE ZONING ORDINANCE, BLIC WORKS STANDARDS AND SPECIFICATIONS. THE ND DEVELOPMENT DEPARTMENT SHALL NOT SPONSIBILITY FOR ANY DELETIONS OR OMISSIONS FROM THE SPECIAL PERMIT REVIEW PROCESS OR DNS OR ALTERATIONS TO CONSTRUCTION PLAN NOT LY SUBMITTED AND REVIEWED AND APPROVED TO THIS SPECIAL PERMIT OR SUBSEQUENT TS OR REVISIONS. LAND, BUILDINGS, OR STRUCTURES OTHER THAN CIFICALLY APPROVED PURSUANT TO THIS SITE PLAN ERMITTED. D UTILITY BOXES, TRANSFORMERS, METERS, PIPING THE BACKFLOW PREVENTION DEVICE), ETC., ARE D BE LOCATED IN THE LANDSCAPE AREAS OR R ON THE STREET FRONTAGES OF THE BUILDINGS. ORMERS, ETC., SHALL BE SHOWN ON THE SITE PLAN. OW DEVICE SHALL BE SCREENED BY LANDSCAPING THER MEANS AS MAY BE APPROVED. NG MUST BE IN PLACE BEFORE ISSUANCE OF THE E OF OCCUPANCY. NAL INSPECTION, A WRITTEN CERTIFICATION, A LANDSCAPE PROFESSIONAL APPROVED BY THE SHALL BE SUBMITTED STATING THAT THE REQUIRED NG AND IRRIGATION SYSTEM WAS INSTALLED IN CE WITH THE LANDSCAPING AND IRRIGATION PLANS BY THE PLANNING DIVISION, DEVELOPMENT UT. L BE MAINTAINED IN GOOD HEALTH. HOWEVER, NOT BE TRIMMED OR PRUNED TO REDUCE THE IGHT OR OVERALL CROWN OF THE TREE, EXCEPT AS FOR THE HEALTH OF THE TREE AND PUBLIC SAFETY; DTHERWISE BE APPROVED BY THE PLANNING AND NT DEPARTMENT DIRECTOR. APPED PARKING STALLS SHALL BE PAVED ADJACENT ACCESS RAMPS OR IN STRATEGIC AREAS WHERE APPED SHALL NOT HAVE TO WHEEL OR WALK KED VEHICLES WHILE TRAVELING TO OR FROM ED PARKING STALLS OR RAMPS.	 ACCESSIBLE PARKING STALL EXISTING FENCE TO REMAIN NOT USED PROPOSED LANDSCAPE EXISTING DRIVEWAY APPROACH TO BE WIDENED TO 22' DRIVEWAY APPROACH EXTENSION NEW TRASH ENCLOSURE PER CITY OF FRESNO STD DRAWING P-33 EXISTING 6' HIGH WOOD FENCE TO REMAIN CONCRETE WALK NOT USED EXISTING FIRE HYDRANT EXISTING FIRE HYDRANT EXISTING FOWER POLE ADA PARKING SIGNAGE 6'' HIGH WHEEL STOP (TYP.) BIKE PARKING - 4 SPACES ROOF TOP UNIT - HVAC EXISTING ± 4'-0'' CONCRETE SIDEWALK - PATH OF TRAVEL 4''Ø STEEL POST (TYP. OF 4) 6' HIGH DECORATIVE WROUGHT IRON FENCE 	FRANS PREPARED FOR: 4 UNT APARTMENT 736 N. COLLEGE AVE., FRESNO CA 93650
ER THAN DIRECTIONAL SIGNS, IF APPLICABLE, ARE /ED FOR INSTALLATION AS PART OF THIS SPECIAL // LOGICAL AND/OR ANIMAL FOSSIL MATERIAL IS RED DURING PROJECT SURVEYING, GRADING, G, OR CONSTRUCTION, WORK SHALL STOP Y. RE SUSPECTED HUMAN REMAINS, THE FRESNO RONER SHALL BE IMMEDIATELYCONTACTED. IF THE R OTHER ARCHAEOLOGICAL MATERIAL IS POSSIBLY RICAN INORIGIN, THE NATIVE AMERICAN HERITAGE	LOT LINES EXISTING CURB AND GUTTER 12' HIGH LED SITE LIGHT CONCRETE LANDSCAPE AREA EXISTING TREE TO REMAIN PROPOSED TREE - SEE LANDSCAPE PLAN	$\begin{array}{c} \begin{array}{c} \begin{array}{c} \begin{array}{c} \begin{array}{c} \begin{array}{c} \\ \end{array} \\ \end{array} \\ \end{array} \\ \end{array} \\ \begin{array}{c} \end{array} \\ \end{array} \\ \begin{array}{c} \end{array} \\ \end{array} \\ \end{array} \\ \begin{array}{c} \end{array} \\ \end{array} \\ \end{array} \\ \begin{array}{c} \end{array} \\ \end{array} \\ \begin{array}{c} \end{array} \\ \end{array} \\ \end{array} \\ \begin{array}{c} \end{array} \\ \end{array} \\ \begin{array}{c} \end{array} \\ \end{array} \\ \end{array} \\ \begin{array}{c} \end{array} \\ \end{array} \\ \end{array} \\ \begin{array}{c} \end{array} \\ \end{array} \\ \end{array} \\ \begin{array}{c} \end{array} \\ \end{array} \\ \begin{array}{c} \end{array} \\ \end{array} \\ \end{array} \\ \begin{array}{c} \end{array} \\ \end{array} \\ \begin{array}{c} \end{array} \\ \end{array} \\ \end{array} \\ \begin{array}{c} \end{array} \\ \end{array} \\ \end{array} \\ \begin{array}{c} \end{array} \\ \end{array} \\ \end{array} \\ \end{array} \\ \begin{array}{c} \end{array} \\ \end{array} \\ \end{array} \\ \end{array} \\ \begin{array}{c} \end{array} \\ \end{array} $
N (PHONE: (916) 653-4082) SHALL BE Y CONTACTED, AND THE CALIFORNIA OGICAL INVENTORY/SOUTHERN SAN JOAQUIN ORMATION CENTER (PHONE: (805) 644-2289) SHALL BE D TO OBTAIN A REFERRAL LIST OF RECOGNIZED OGISTS. AN ARCHAEOLOGICAL ASSESSMENT SHALL TED FOR THE PROJECT, THE SITE SHALL BE RECORDED, AND RECOMMENDATIONS MADE TO THE ANY FURTHER SITE INVESTIGATION OR SITE / PRESERVATION. OSSILS ARE UNCOVERED, THE MUSEUM OF OGY, U.C. BERKELEY SHALL BE CONTACTED TO EFERRAL LIST OF RECOGNIZED PALEONTOLOGIST AN NT SHALL BE CONDUCTED BY A PALEONTOLOGIST PALEONTOLOGIST DETERMINES THE MATERIAL TO ANT, IT SHALL BE PRESERVED.	W EXISTING OFF-SITE WATER VALVE S EXISTING SEWER MANHOLE W PROPOSED WATER METER G PROPOSED GAS METER BP PROPOSED RPBP ▲ DIRECTIONAL ARROW	REVISION(S):
DALL EXISTING OFFSITE OVERHEAD UTILITIES LIMITS OF THIS SITE/ MAP AS PER FMC SECTION D RES. NO. 78-522/ 88-229. DAMAGED AND/OR OFF-GRADE CONCRETE STREET NTS AS DETERMINED BY THE CONSTRUCTION NT ENGINEER PRIOR TO OCCUPANCY.	PINEDALE BOYS & N GIRLS CLUBS W. MINARETS AVENUE 7236 N. COLLGE AVENUE FRESNO, CA 93650	DRAWN BY : AT
DAYS BEFORE COMMENCING EXCAVATION WITHIN THE STREET RIGHT-OF-WAY AND/OR UTILITY 6, ALL EXISTING UNDERGROUND FACILITIES SHALL LOCATED BY UNDERGROUND SERVICES ALERT - 1-800-642-2444. Y MONUMENTS WITHIN THE AREA OF CONSTRUCTION	W. BIRCH AVENUE W. BIRCH AVENUE W. SPRUCE AVENUE W. SPRUCE AVENUE	CHECKED BY : CZ DATE: 3-12-20 SHEET TITLE: SITE PLAN
RESERVED OR RESET BY A PERSON LICENSED TO AND SURVEYING IN THE STATE OF CALIFORNIA G DRIVEWAY APPROACHES WHICH NO LONGER PROVED ACCESS SHALL BE REMOVED AND	$ \begin{array}{c c} z & & & & \\ \hline \\ \hline$	SHEET: A1.0


PROVIDE APPROVED ACCESS SHALL BE REMOVED AND REPLACED WITH CURB, GUTTER AND SIDEWALK PER P.W. STD. P5

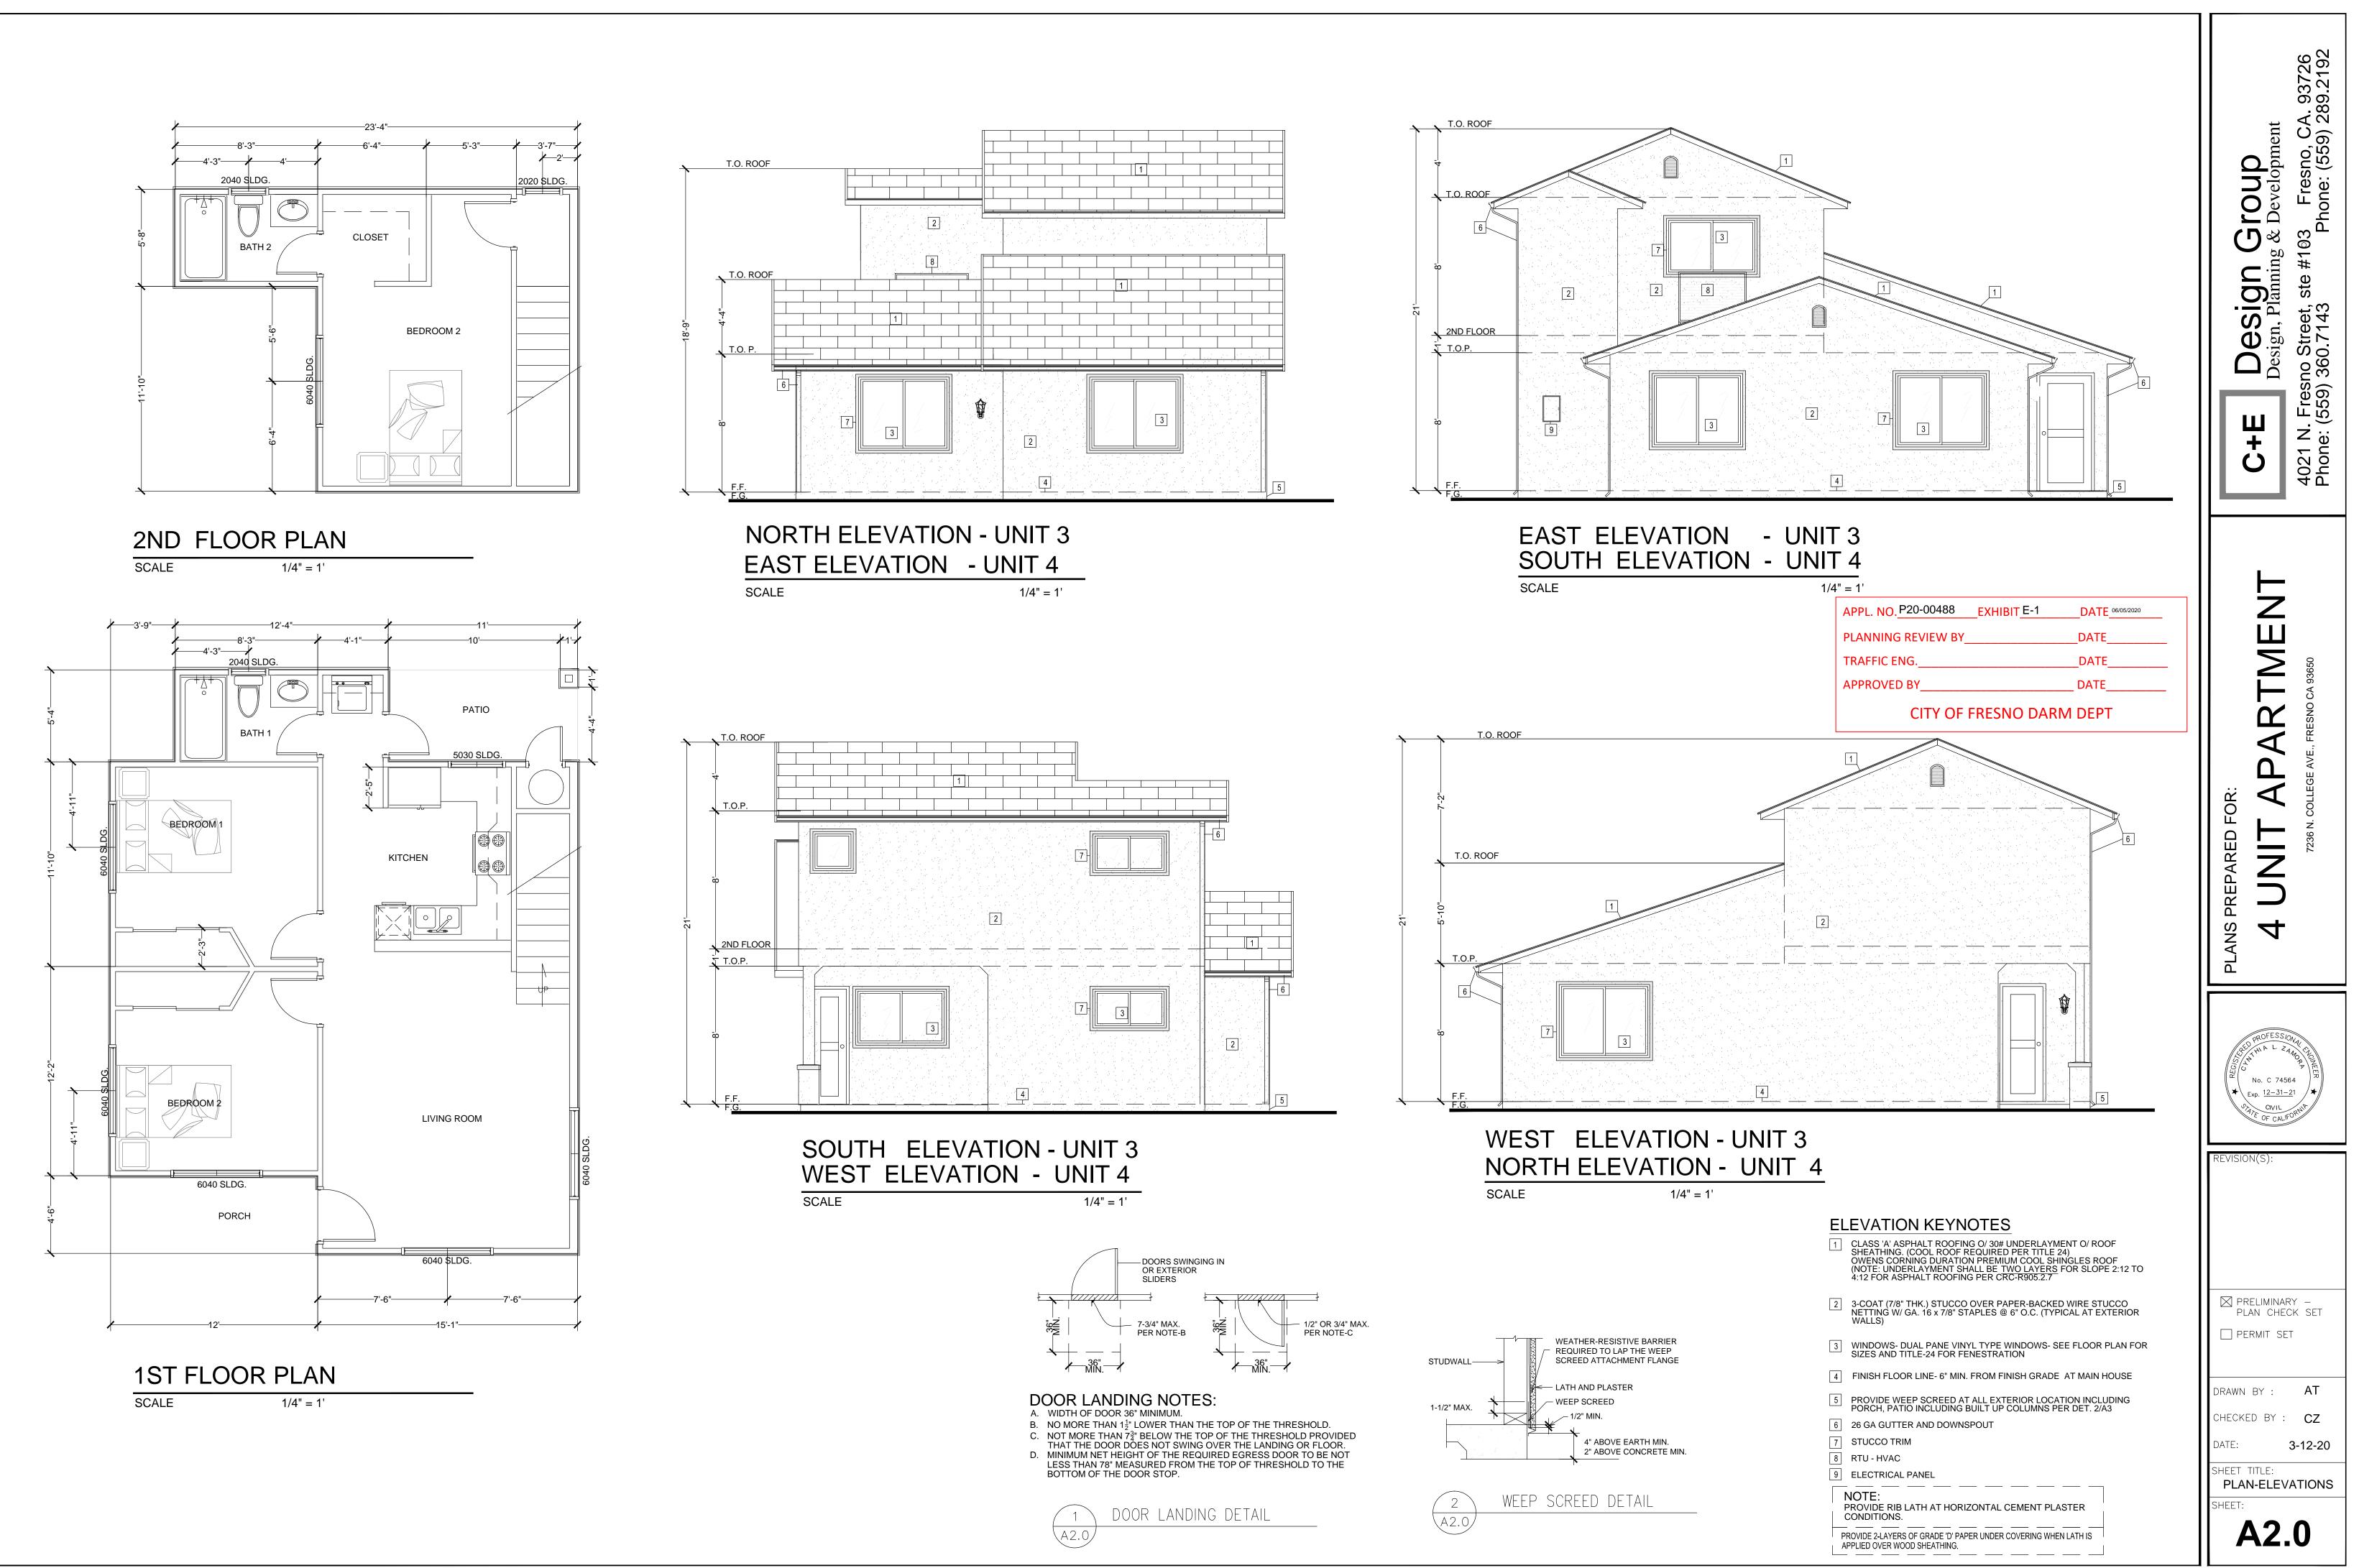


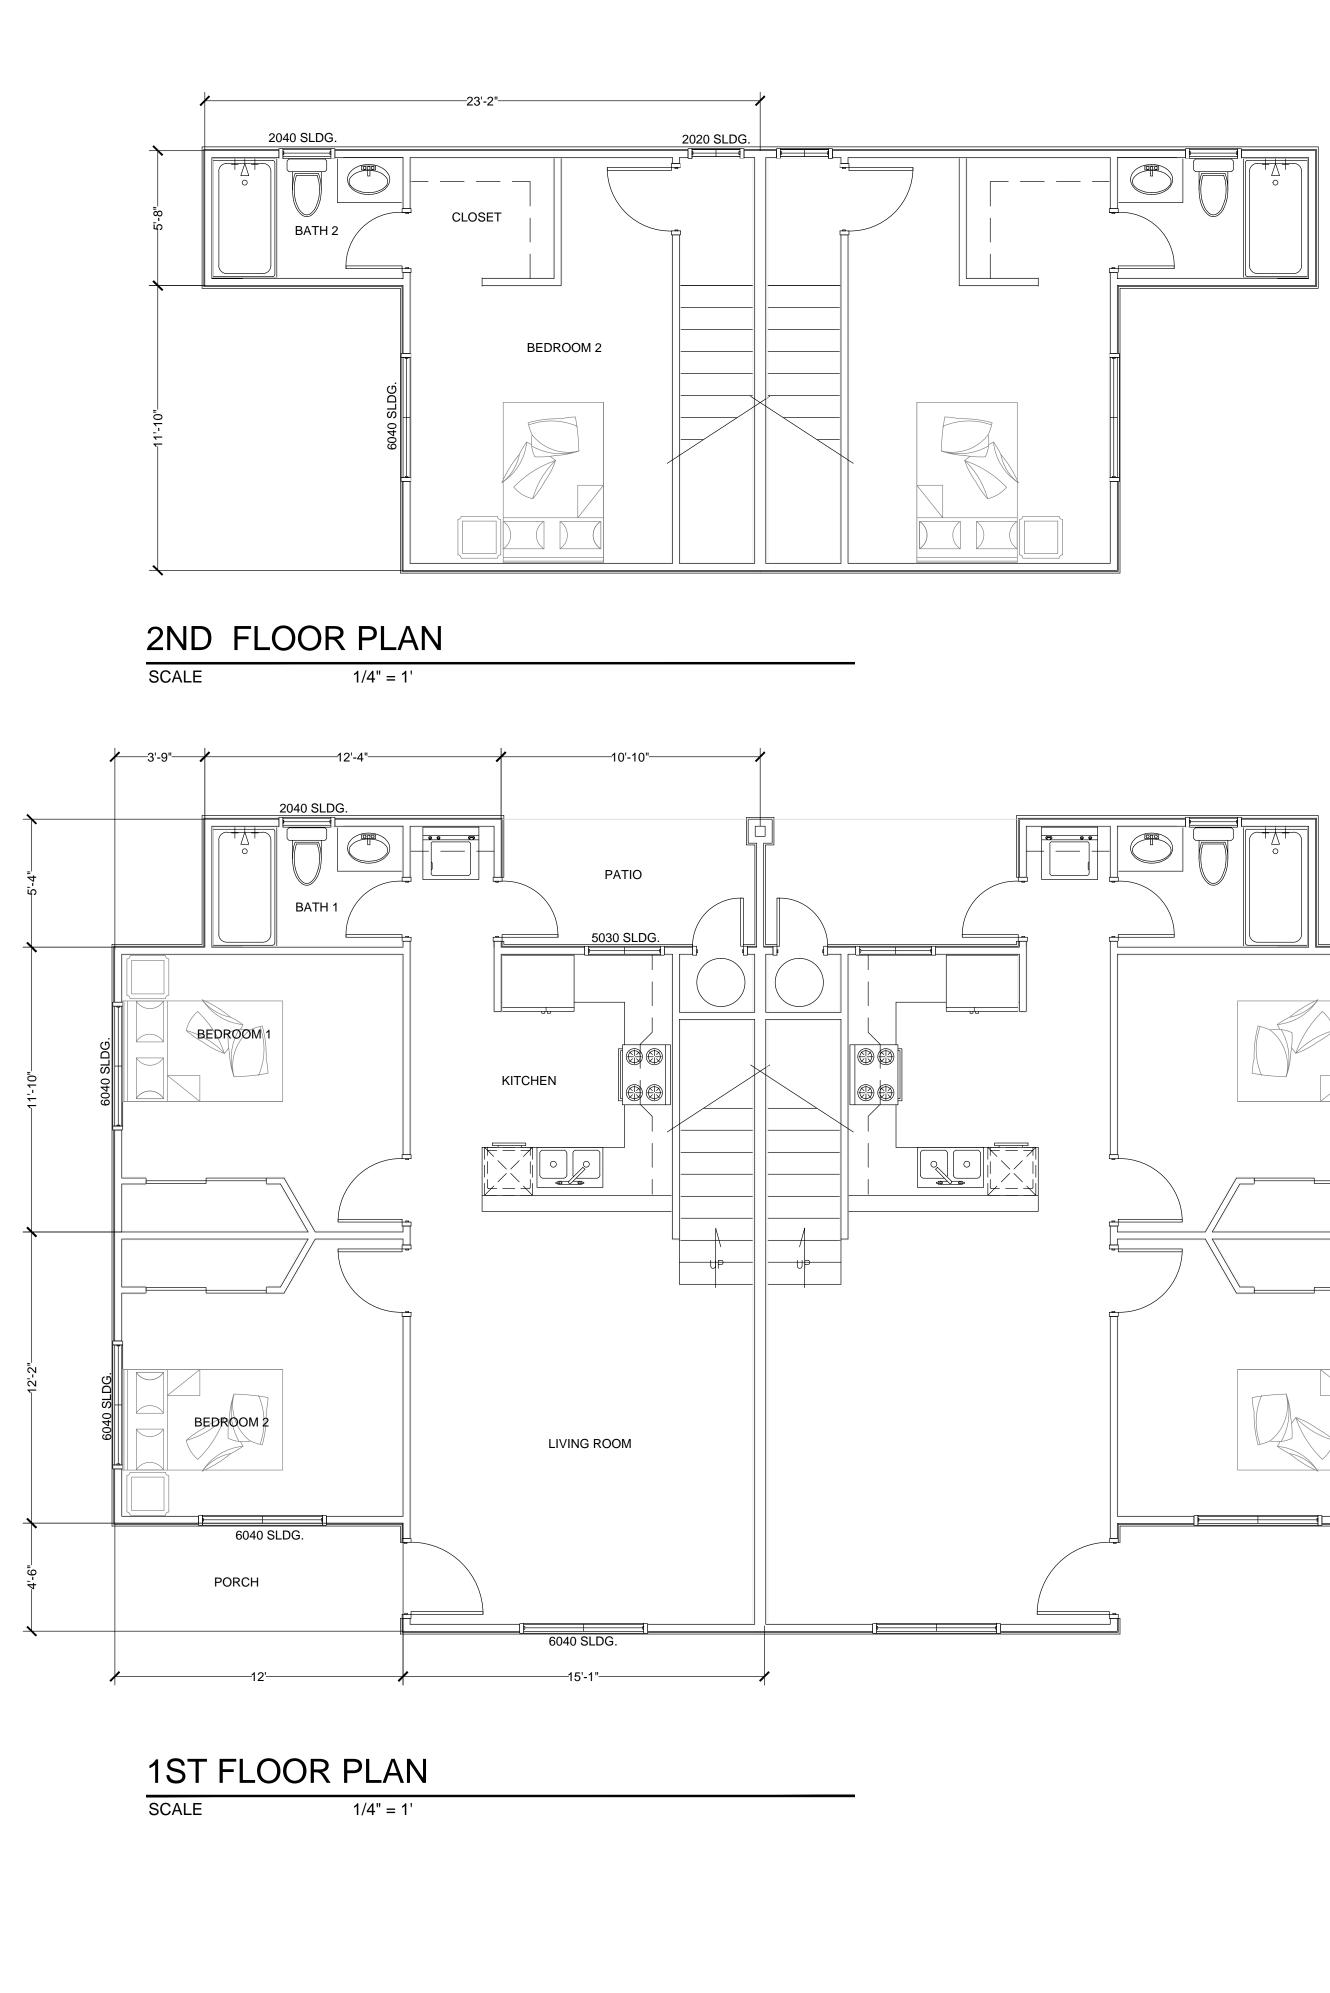




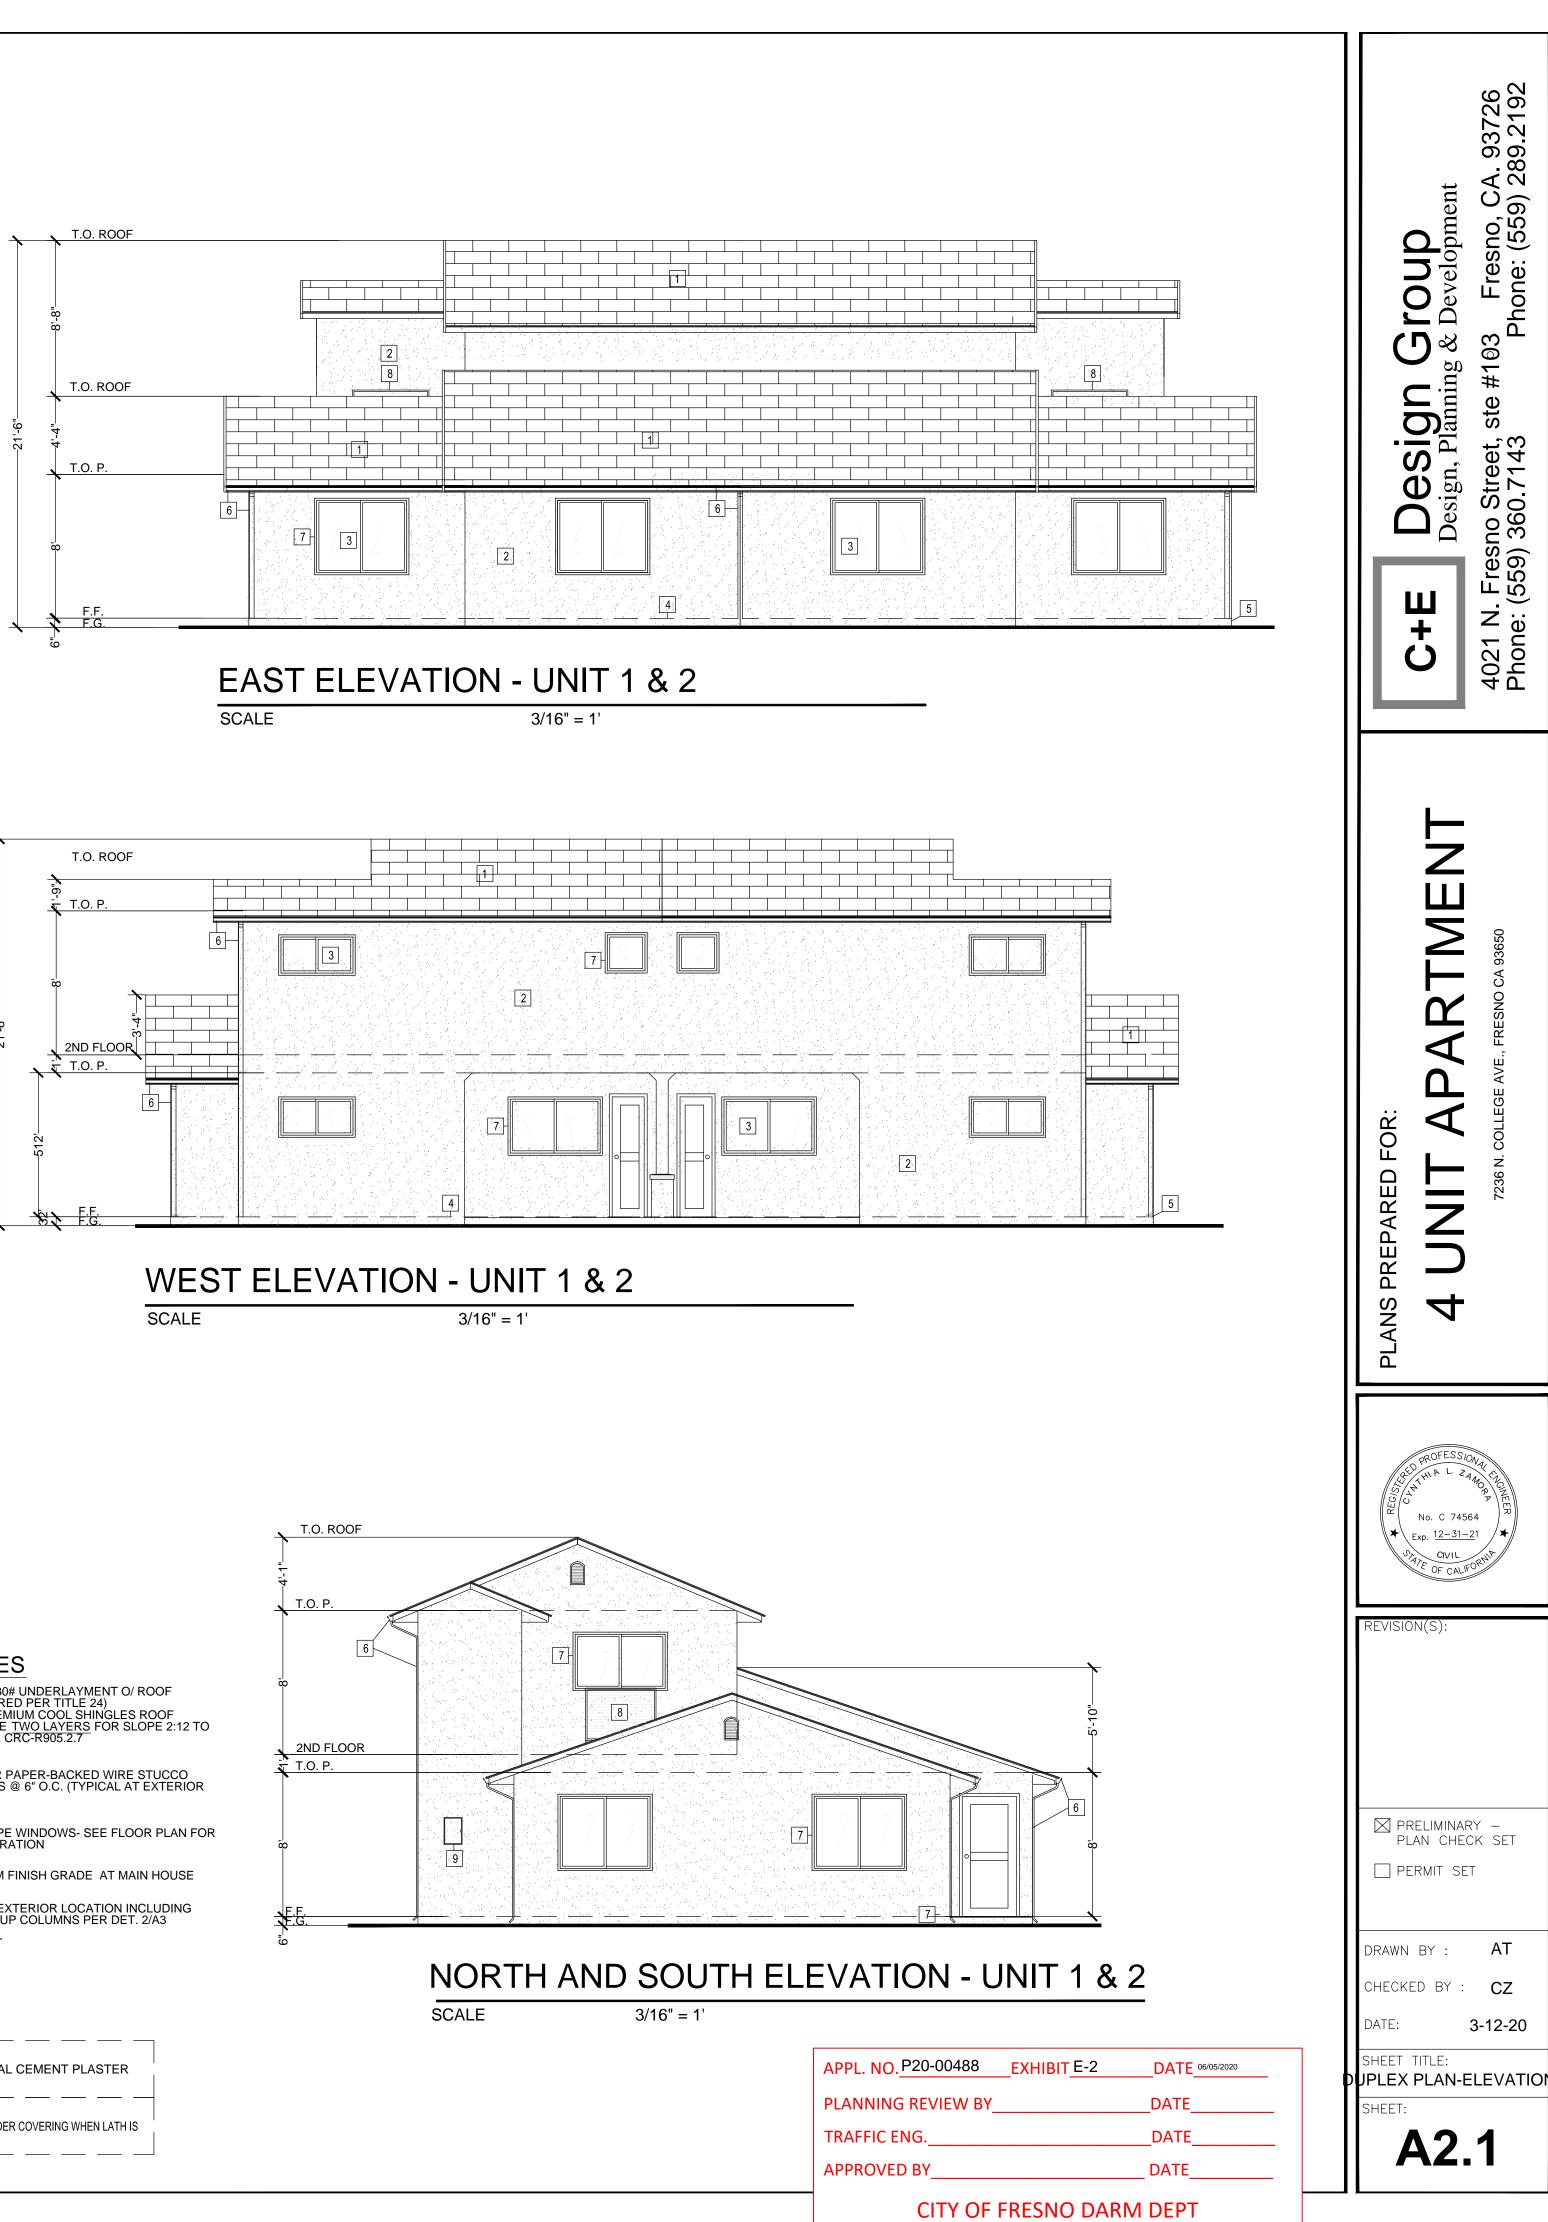

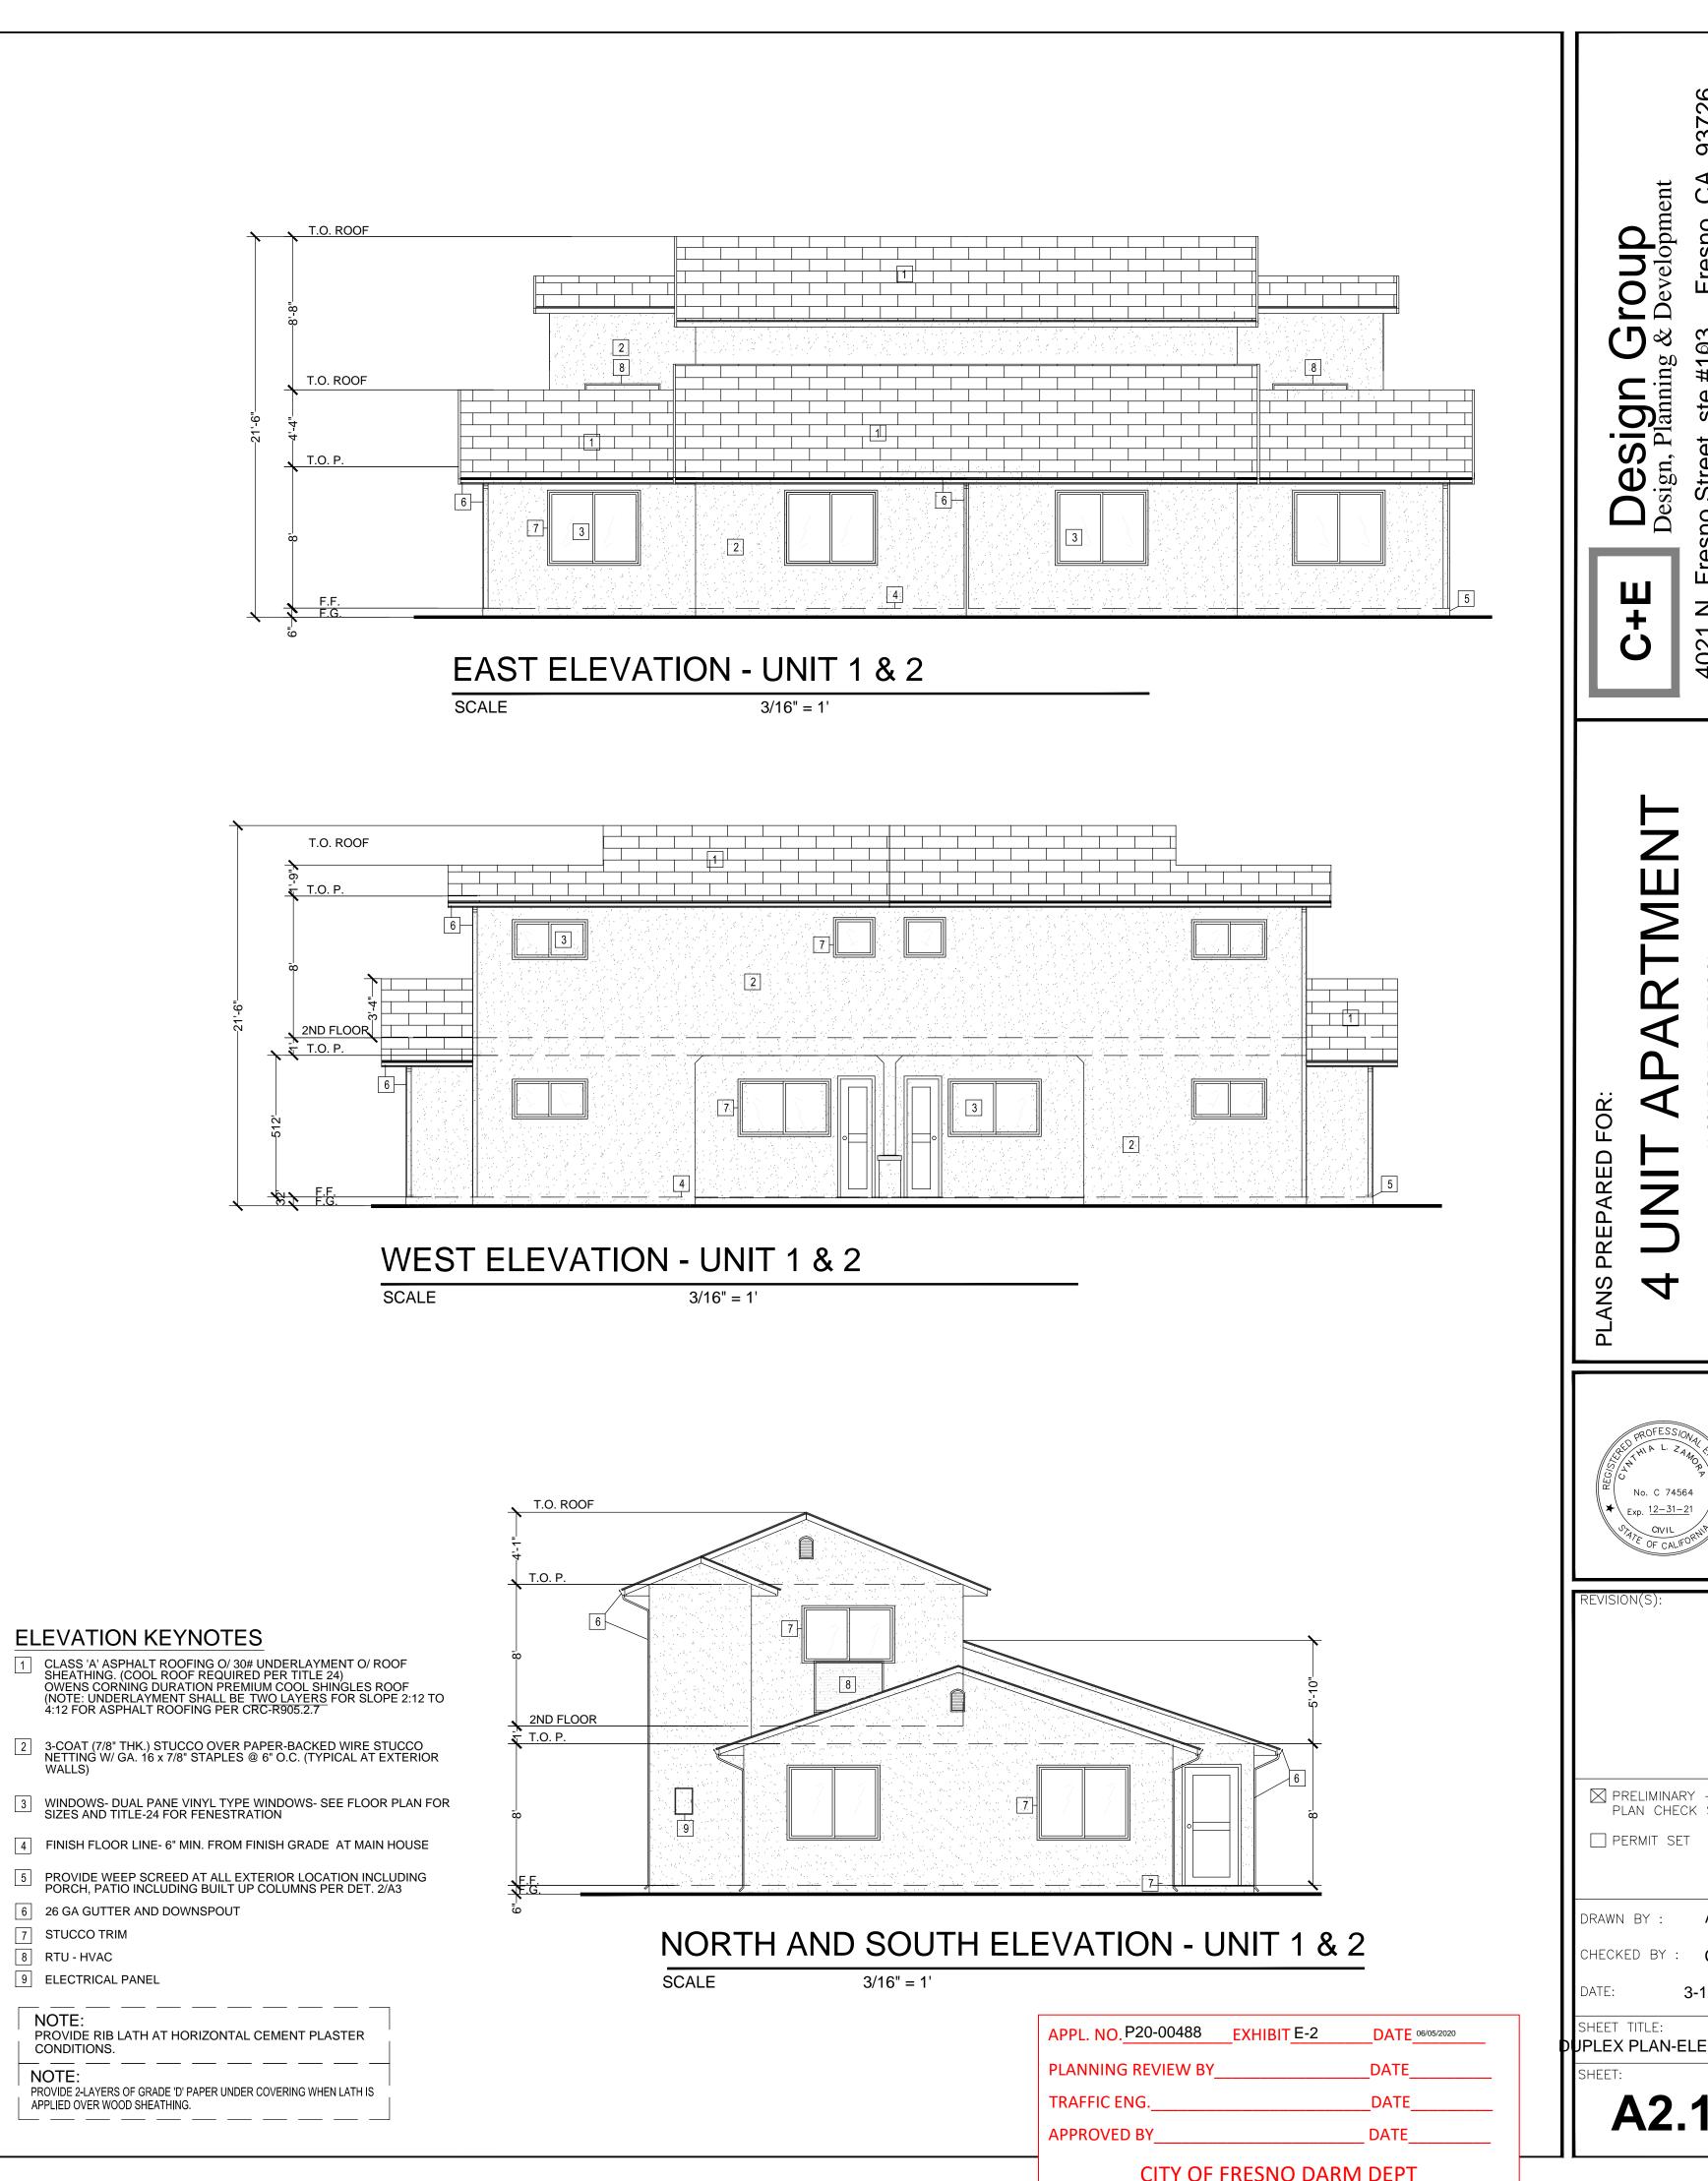


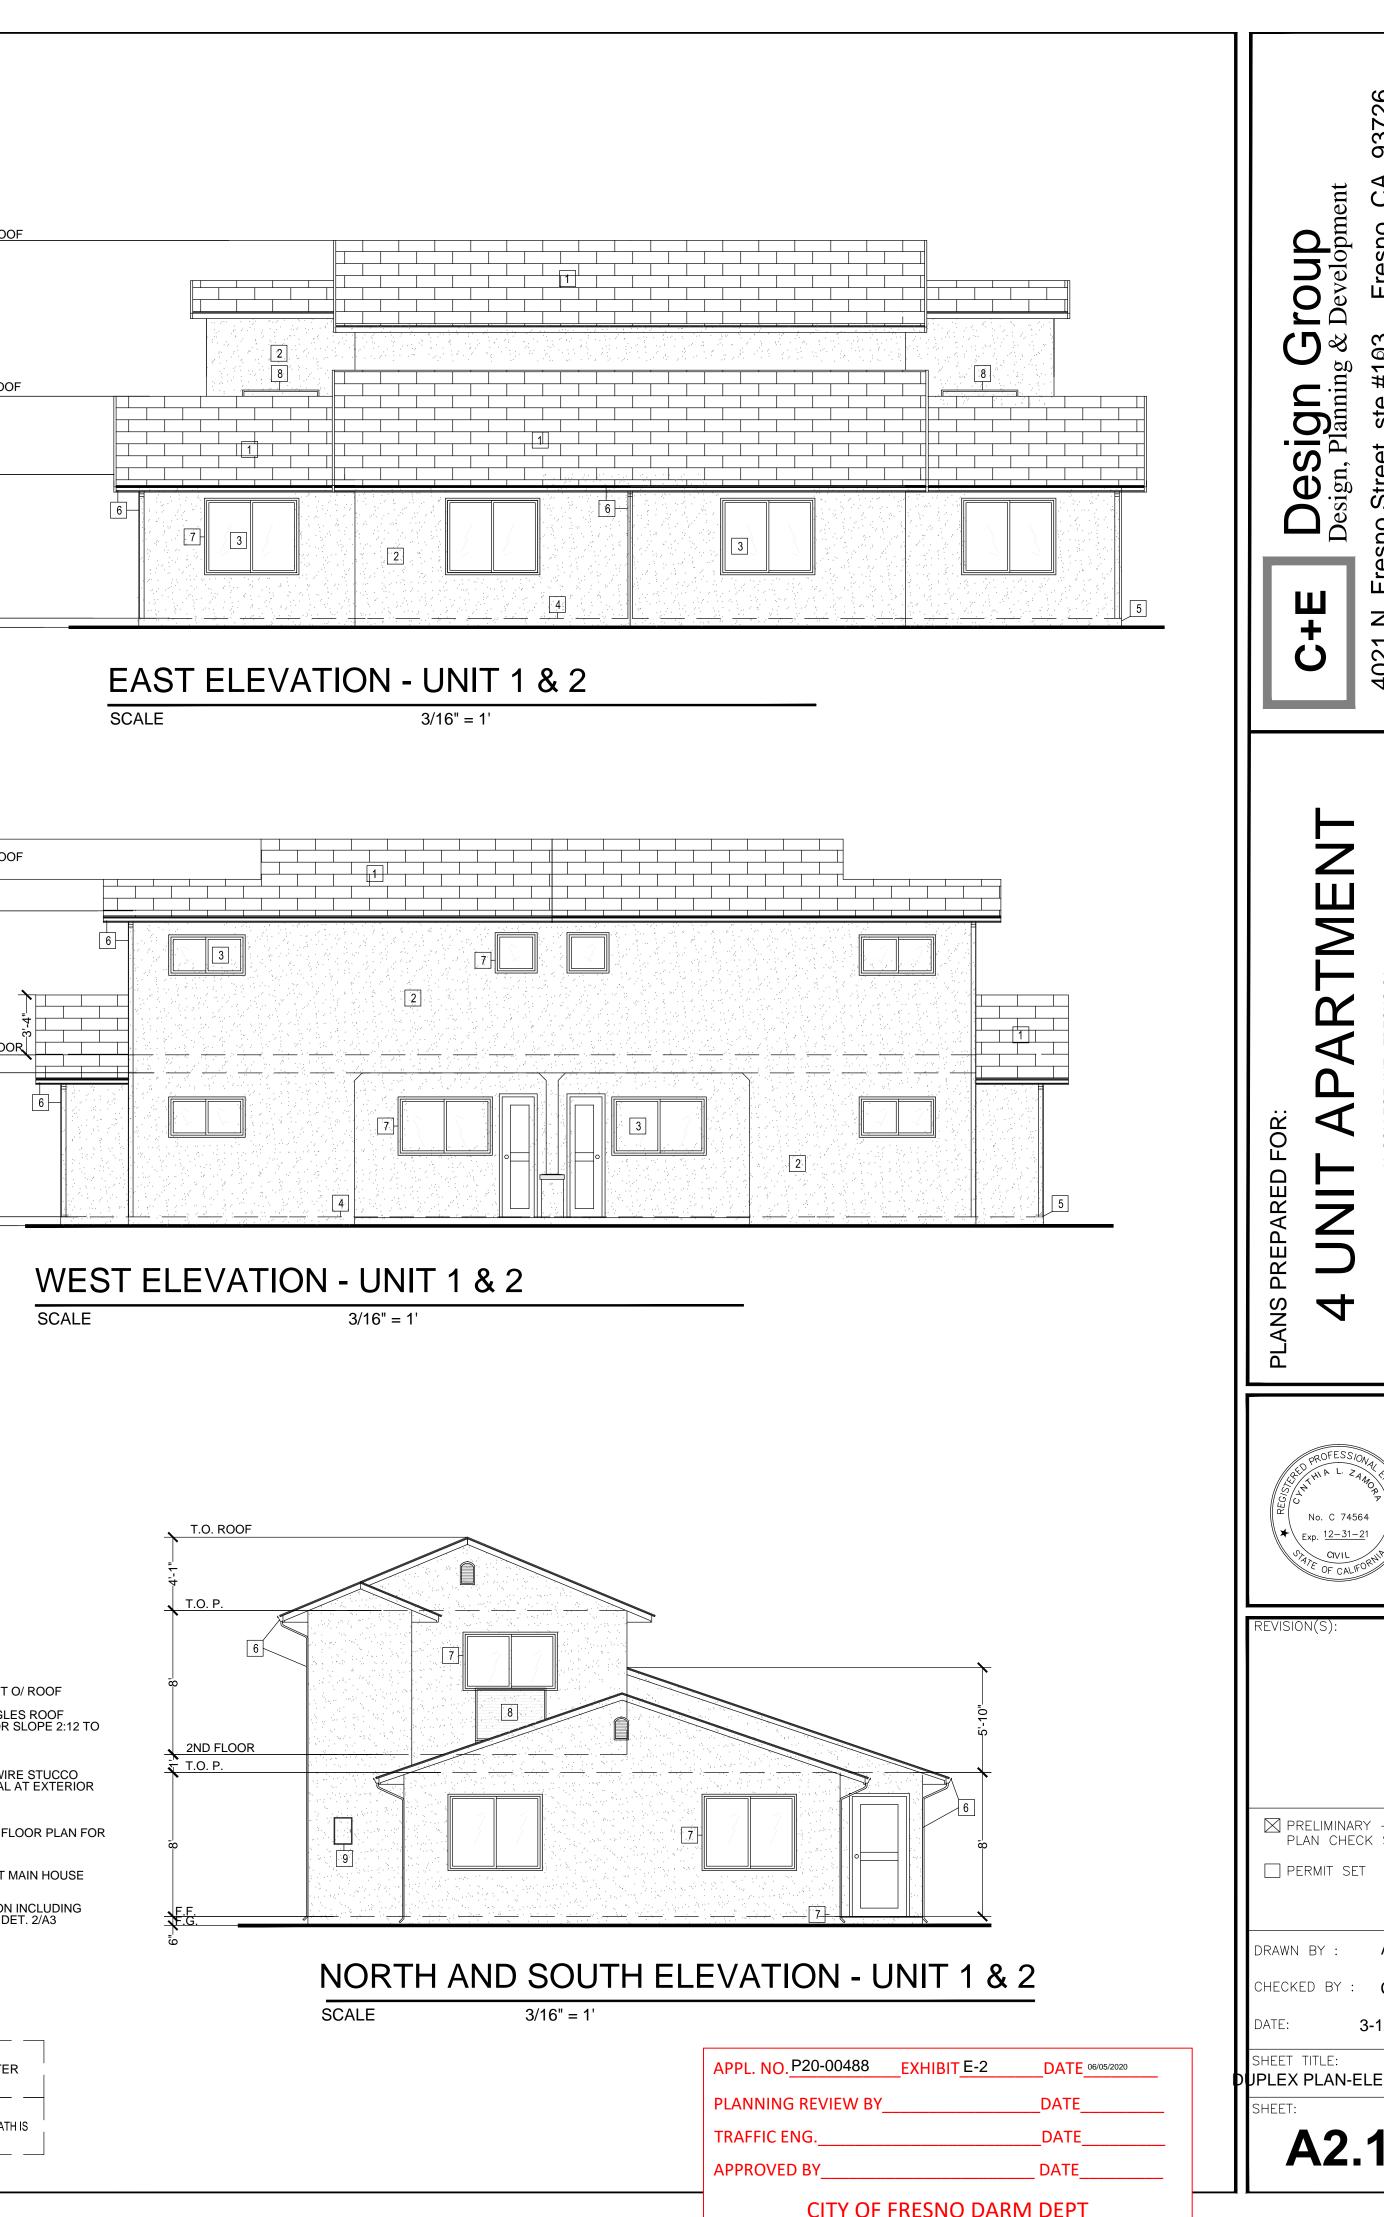


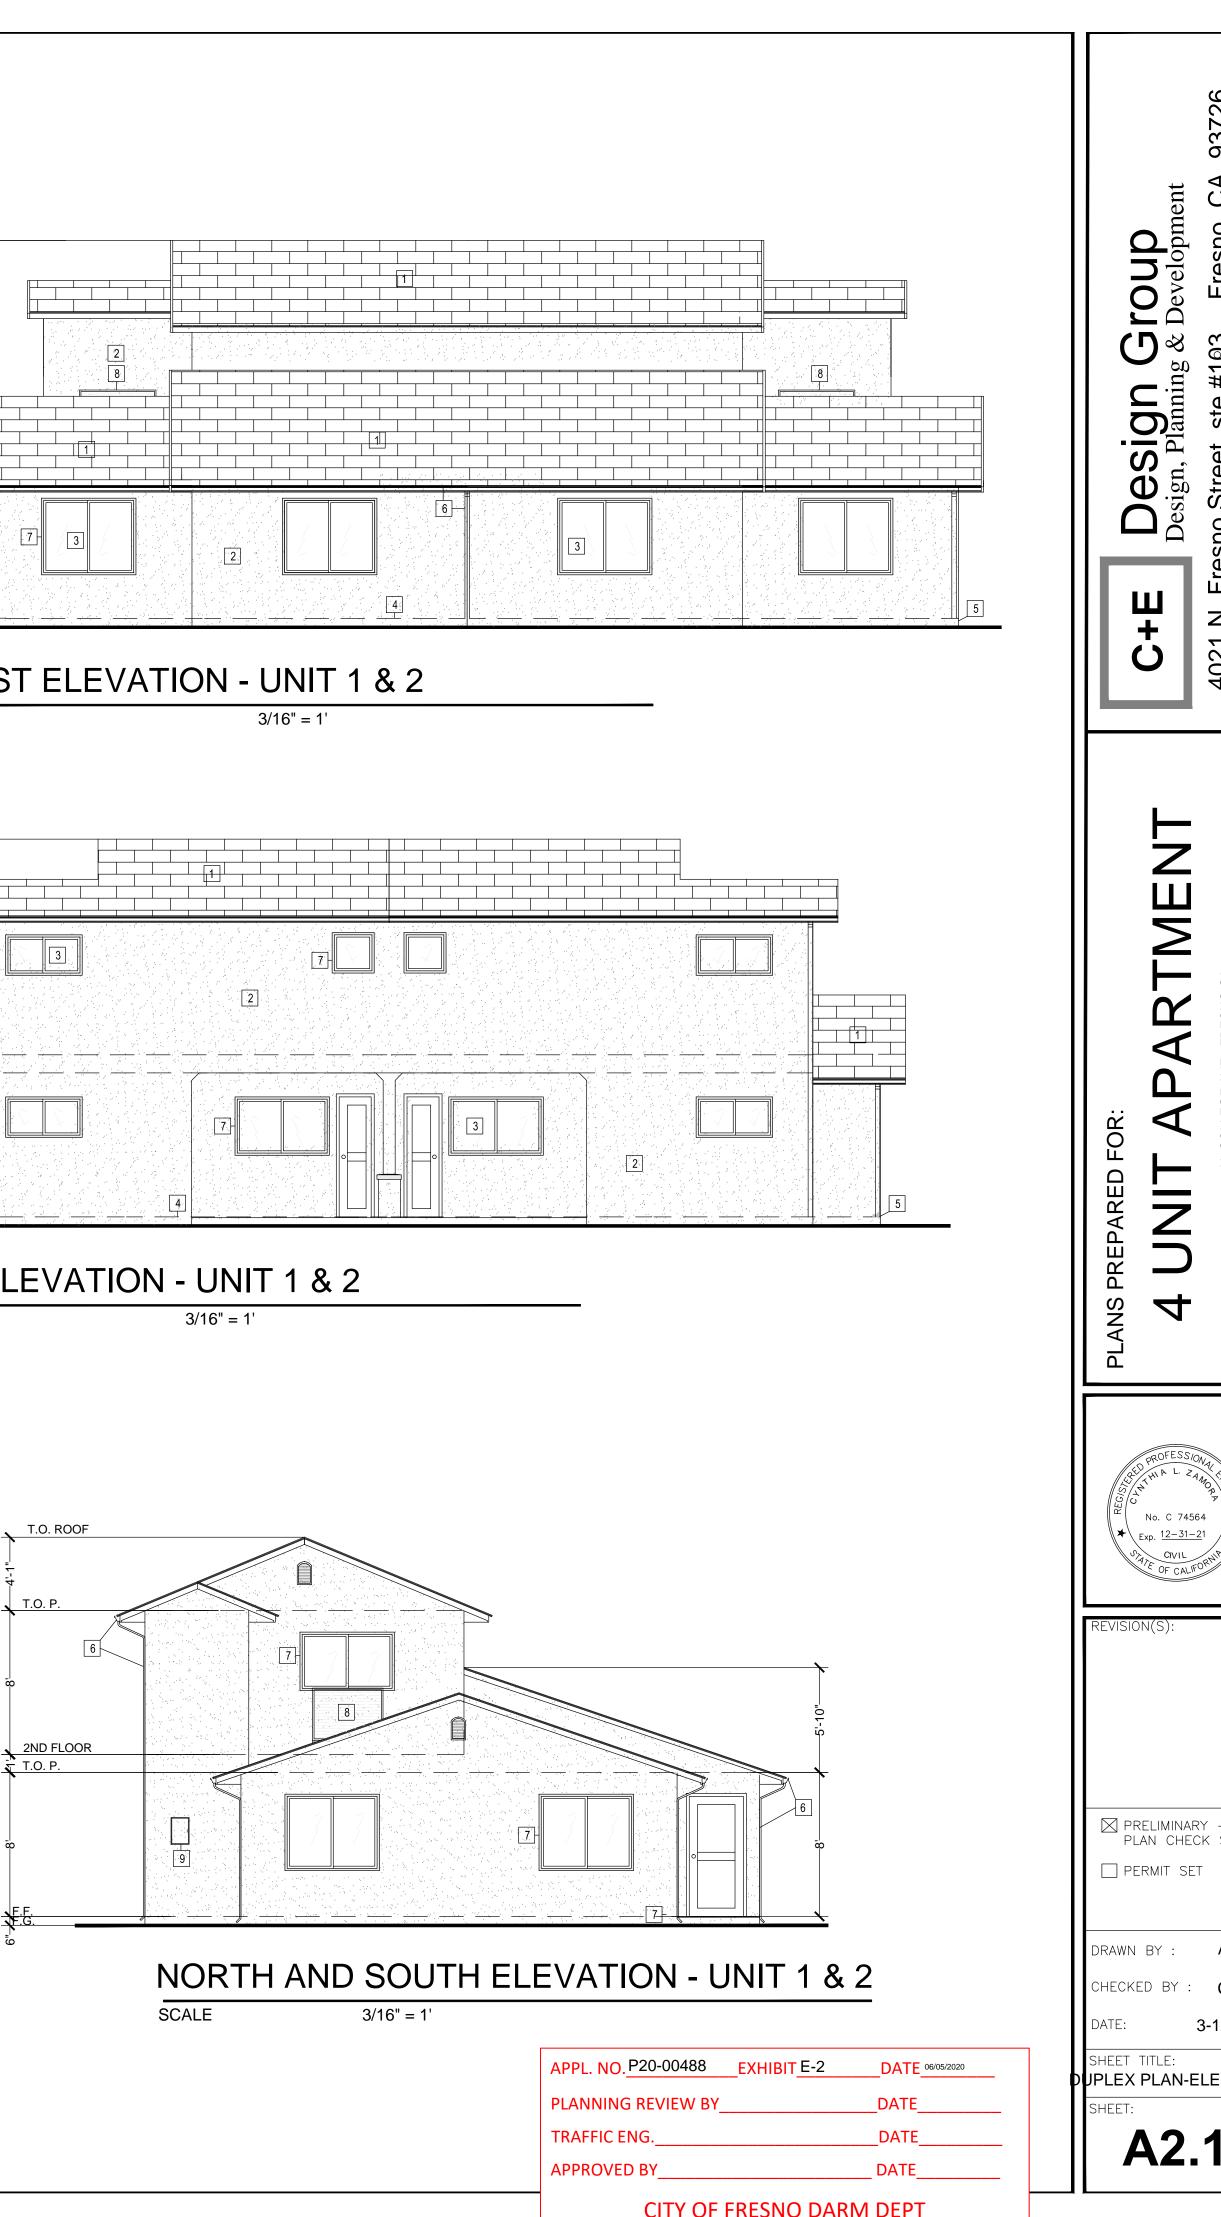

ELEVATION KEYNOTES

- 1CLASS 'A' ASPHALT ROOFING O/ 30# UNDERLAYMENT O/ ROOF
SHEATHING. (COOL ROOF REQUIRED PER TITLE 24)
OWENS CORNING DURATION PREMIUM COOL SHINGLES ROOF
(NOTE: UNDERLAYMENT SHALL BE TWO LAYERS FOR SLOPE 2:12 TO
4:12 FOR ASPHALT ROOFING PER CRC-R905.2.7
- 3 WINDOWS- DUAL PANE VINYL TYPE WINDOWS- SEE FLOOR PLAN FOR SIZES AND TITLE-24 FOR FENESTRATION
- 4 FINISH FLOOR LINE- 6" MIN. FROM FINISH GRADE AT MAIN HOUSE
- 5 PROVIDE WEEP SCREED AT ALL EXTERIOR LOCATION INCLUDING PORCH, PATIO INCLUDING BUILT UP COLUMNS PER DET. 2/A3
- 6 26 GA GUTTER AND DOWNSPOUT
- 7 STUCCO TRIM
- 8 RTU HVAC
- 9 ELECTRICAL PANEL

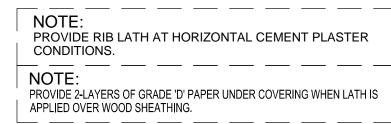


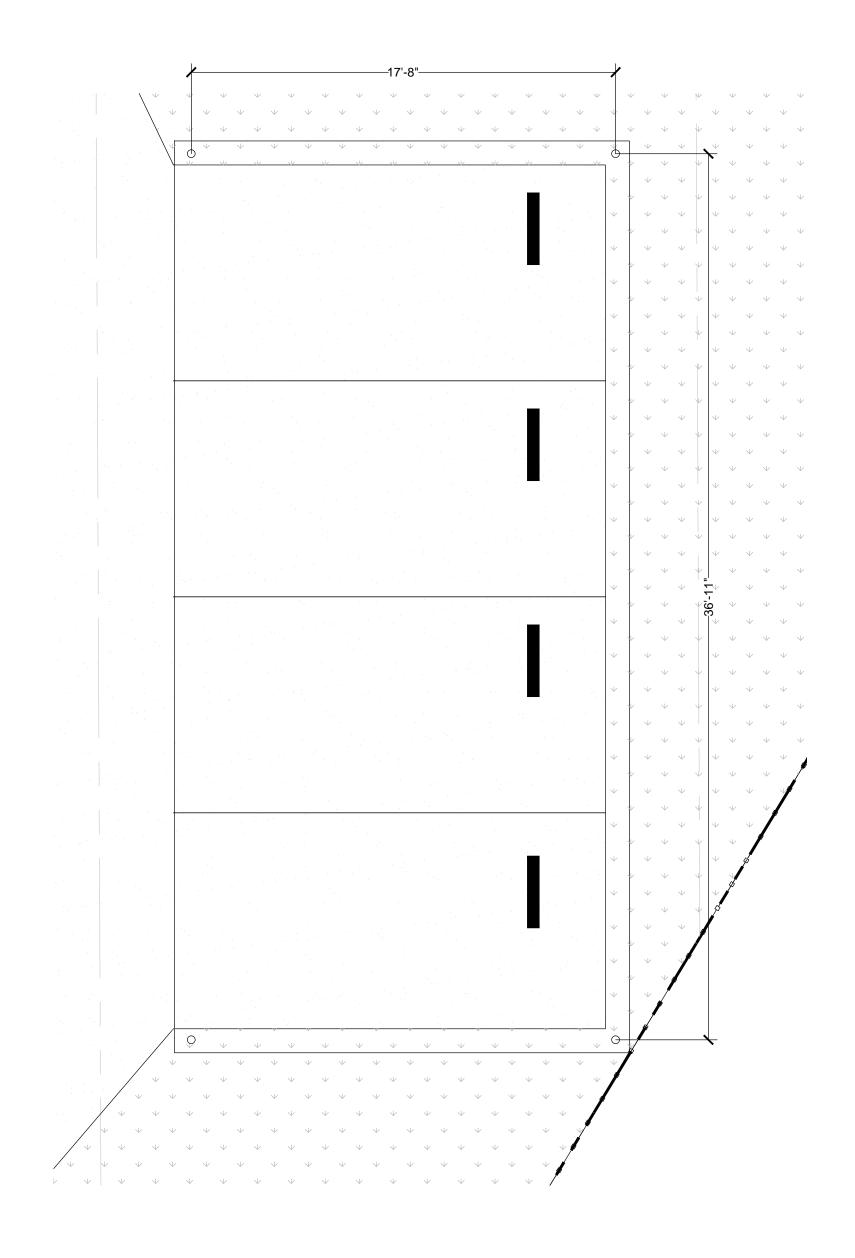




SCALE

1/4" = 1'-0"_XREF

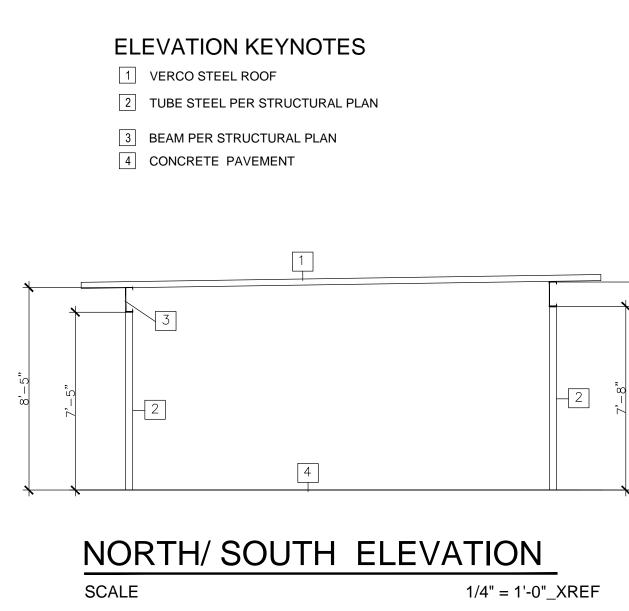

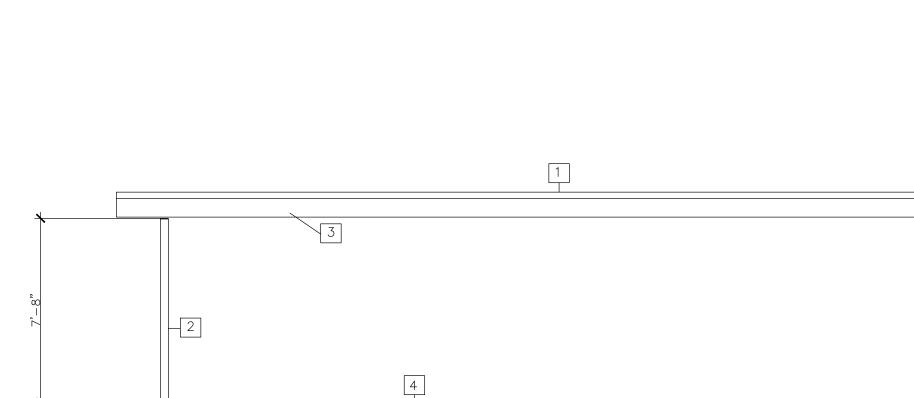


EAST/ WEST ELEVATION


SCALE

1/4" = 1'-0"_XREF


		C+E Design Group Design, Planning & Development 4021 N. Fresno Street, ste #103 Fresno, CA. 93726 Phone: (559) 360.7143 Phone: (559) 289.2192
		PLANS PREPARED FOR: 4 UNIT APARTMENT 7236 N. COLLEGE AVE., FRESNO CA 93650
		REVISION(S):
APPL. NO. P20-00488 EXHIBIT E-3 PLANNING REVIEW BY TRAFFIC ENG APPROVED BY CITY OF FRESNO DARN	DATE DATE DATE	DRAWN BY : AT CHECKED BY : CZ DATE: 3-12-20 SHEET TITLE: CARPORT SHEET: A2.2

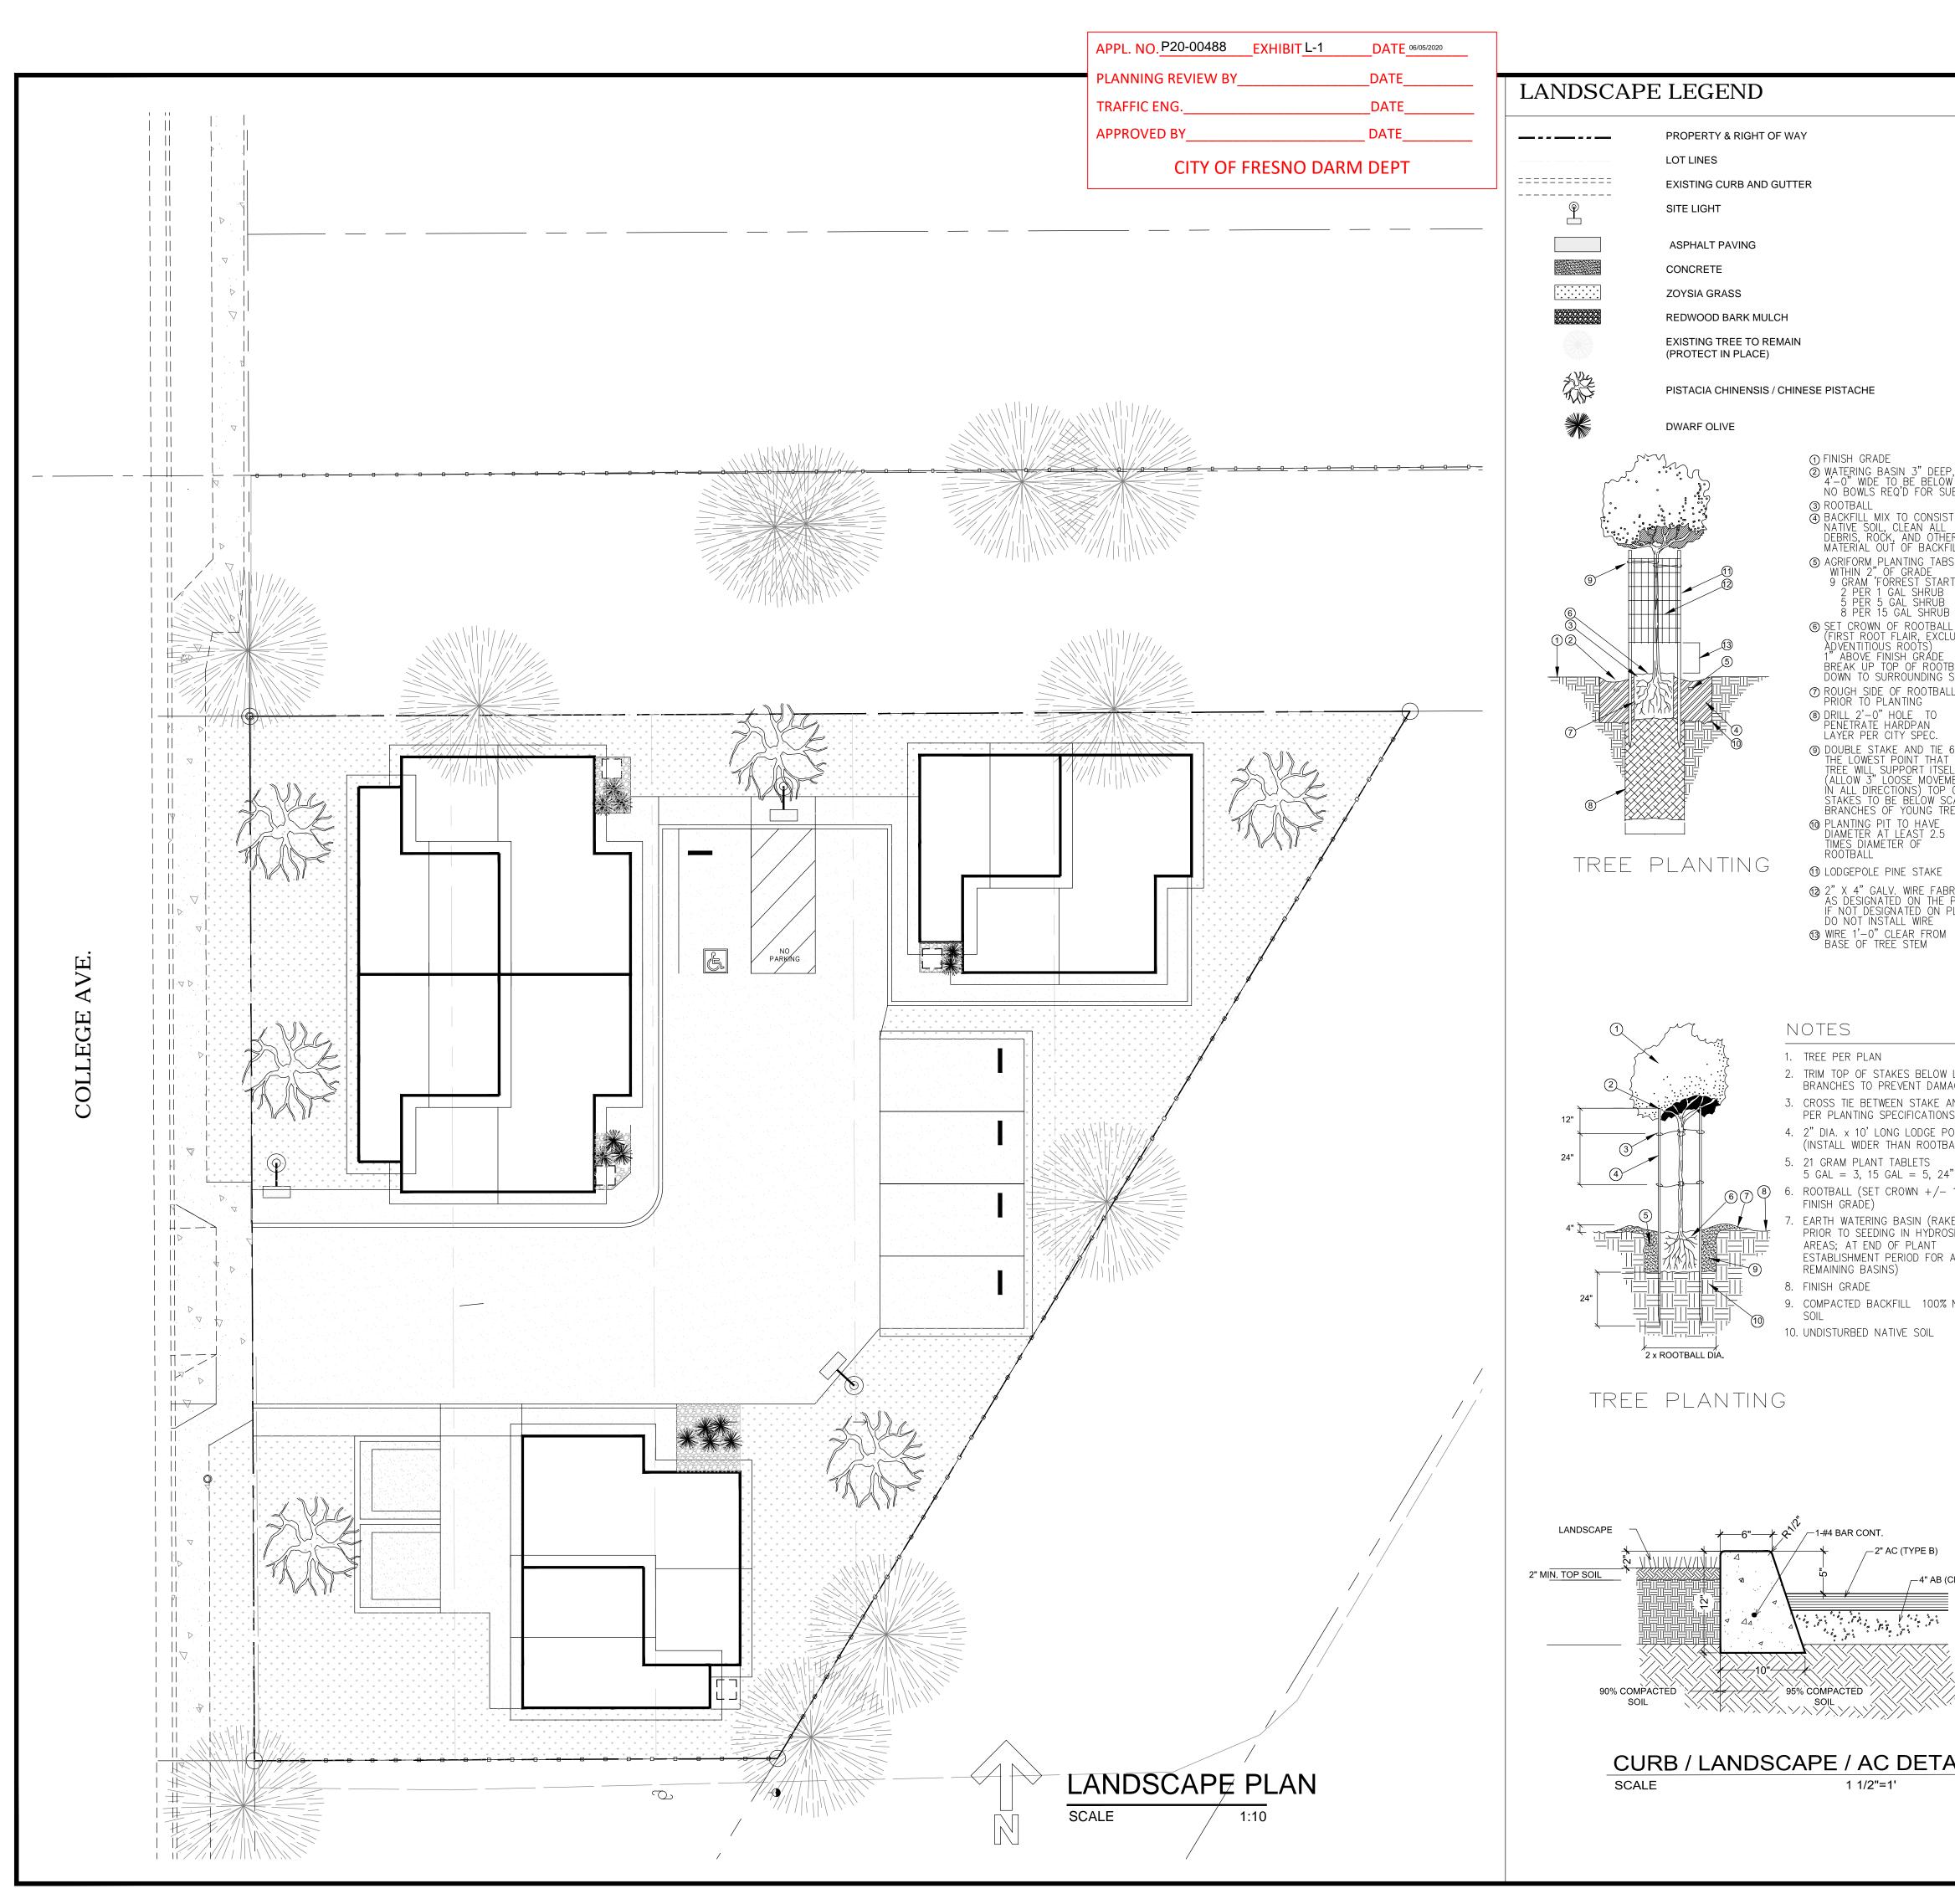

<u> </u>		CL II)			ALL	1" ABOVE KE SMOOTH ISEED	IS POLE STAKES BALL)	LOWEST AGE AND TREE	BRIC PLANS PLANS	BALL SOIL LEVEL. LL 6"ABOVE ELF MENT- OF CAFFOLD REE	2S RTER' 3 LL LUDING	P, W GRADE JBSURFACE DRIP ST OF ER FILL		
7.	6.	4. 5.	2. 3.	0. 11.	8. 9.	7.	5. 6.	3. 4.	1. 2.	7.	5.	4.	2.	1.
Prior to top dressing, use pre-emergent herbicide, 'Ronstar" at a rate of 5 lbs per 1000 sq. ft Controlled release fertilizer tablets to be added per manufacturers recommendations.	Soil sulfur Gro-power Plus Planting beds shall be top dressed with DECOMPOSED GRANITE (DG) at a rate of 2 inches thick. (6 cu yard per 1000 s.f.)	Landscape areas to be rough graded plus or minus a tenth of a foot by others. All on-grade planting areas shall be cross ripped to a depth of 10–12 inches in two directions and receive per thousand square feet of area the following: Kellogg's 'Nitro-humus' 12–12–12 Commercial fertilizer 6 cu yards 15 lbs	 grades have been been been been properly graded and some prepared, and the work approved by Landscape Arhitect. All existing trees to remain shall be protected from damage due to construction. Provide protective barrier throughout construction. The contractor shall be responsible for replacement and reconditioning the existing landscape damaged by this construction contract. Replacement and reconditioning will include but not be necessarily limited to: turf establishment (ripping, soil preparation, soil conditioning, fine grading and seeding); tree, shrub, and ground cover replacement, etc. 	Architect, will result in contractors responsibility to relocate the materials at no expense to Owner.All ground cover shall extend beneath taller plant material.No planting shall be done until installation of the irrigation system is completed, final grades have been established, planting areas have been properly graded and soil	See details and specifications for staking method, plant pit dimensions and backfill requirements. If conflicts arise between size of areas and plans, contractor shall contact Riverside Landscaping for resolution. Failure to make such conflicts known to Landscape	Contractor shall notify Owner's authorized representative 48 hours prior to commencement of work to coordinate project observation schedules.	All plant material shall be approved by the Owner's authorized representative prior to installation. Final location of all plant materials shall be subject to the approval of the Owner's authorized representative.	Contractor shall be responsible for any coordination with subcontractors as required to accomplish planting operations. See specifications for planting requirements, materials and execution.	SUPPLEMENTAL NOTES Quantities shown are Designer's estimate only. Contractor shall be responsible for the installation of all material appearing on the plan. Do not willfully proceed with construction as designed when it is obvious that unknown obstructions and/or grade differences exist that may not have been known during design. Such conditions shall be immediately brought to the attention Landscape Architect. The contractor shall assume full responsibility for all necessary revisions due to failure to give such notification.	Prior to final inspection. A written certification, signed by a landscape professional, shall be submitted stating that the required landscaping and irrigation system was installed in accordance with the Landscape and Irrigation plans approved by the Planning Division, Development Department No structures of any kind my be installed or maintained within the landscaped areas. No exposed utility boxes, transformers, meters, piping, (excepting the backflow prevention device), etc., are allowed to be located in the landscape areas or setbacks or on the street frontages of the buildings. All transformers, etc., shall be shown on the site plan. The backflow device shall be screened by landscaping or such other means as may be approved.	Trees shall be maintained in good health. However, trees may not be trimmed or pruned to reduce the natural height or overall crown of the tree. Except as necessary for the health of the tree and public safety, or as may otherwise be approved by the Public Works Department Landscaping must be in place before issuance of the Certificate of Occupancy	Drilling shall be competed within the 14 days for which clearance was obtained for approved locations. Holes shall be 2 feet in diameter and drilled to a depth where visual evidence of the subsurface sand or gravel drainage stratum is apparent; the drainage hole shall be drilled to a minimum of 10 feet deep. Immediately following drilling, the hole shall be backfilled with soil drilled from the hole, using sufficient water to thoroughly saturate the backfill material. Immediately following backfilling, the white spot designating the planting site is painted black to indicate the site has been drilled. The drilled sites are barricaded and checked daily for 5 working days for soil settling. Soil levels are adjusted as necessary during this time. After 7 days, the barricades and excess soil are removed. Soil shall be allowed to settle for a minimum of 20 days prior to planting.	Trees planted within the right-of-way shall be located with the following minimum setbacks 30' from street corners for visibility 15' from driveways, stop signs, alleys, light poles, and power poles. 10' from fire hydrants & 8' from sewer lines 5' from building overhangs 2' from adjacent concrete and adjoining property lines 3' from gas, electrical, and water lines, and roof drains Not used.	GENERAL NOTES Trees planted in the right-of-way shall be planted by the property owner after first obtaining street tree planting permit and a street work permit.
SHEET TITLE: LANDSCAPE PLAN SHEET: L1.0	DRAWN BY : AT CHECKED BY : CZ DATE: 8-24-19	PRELIMINARY — PLAN CHECK SET PERMIT SET		No. C 74564 ★ Exp. <u>12-31-19</u> ↓ CIVIL OF CALIFORNIT REVISION(S):	CONTROFESSIONAL CONTRO	<u>Ģ</u>	PLANS PREP 4 UI	ZAR	ARED FOR: VIT APART 7236 N. COLLEGE AVE., FRESNO CA	RTMENT REND CA 93650	C+E 4021 N. Phone:	E Design, Planning Design, Planning Fresno Street, ste #16 (559) 360.7143	gn Group Ianning & Development ste #103 Fresno, CA. 5 Phone: (559) 28	ıt A. 93726 289.2192

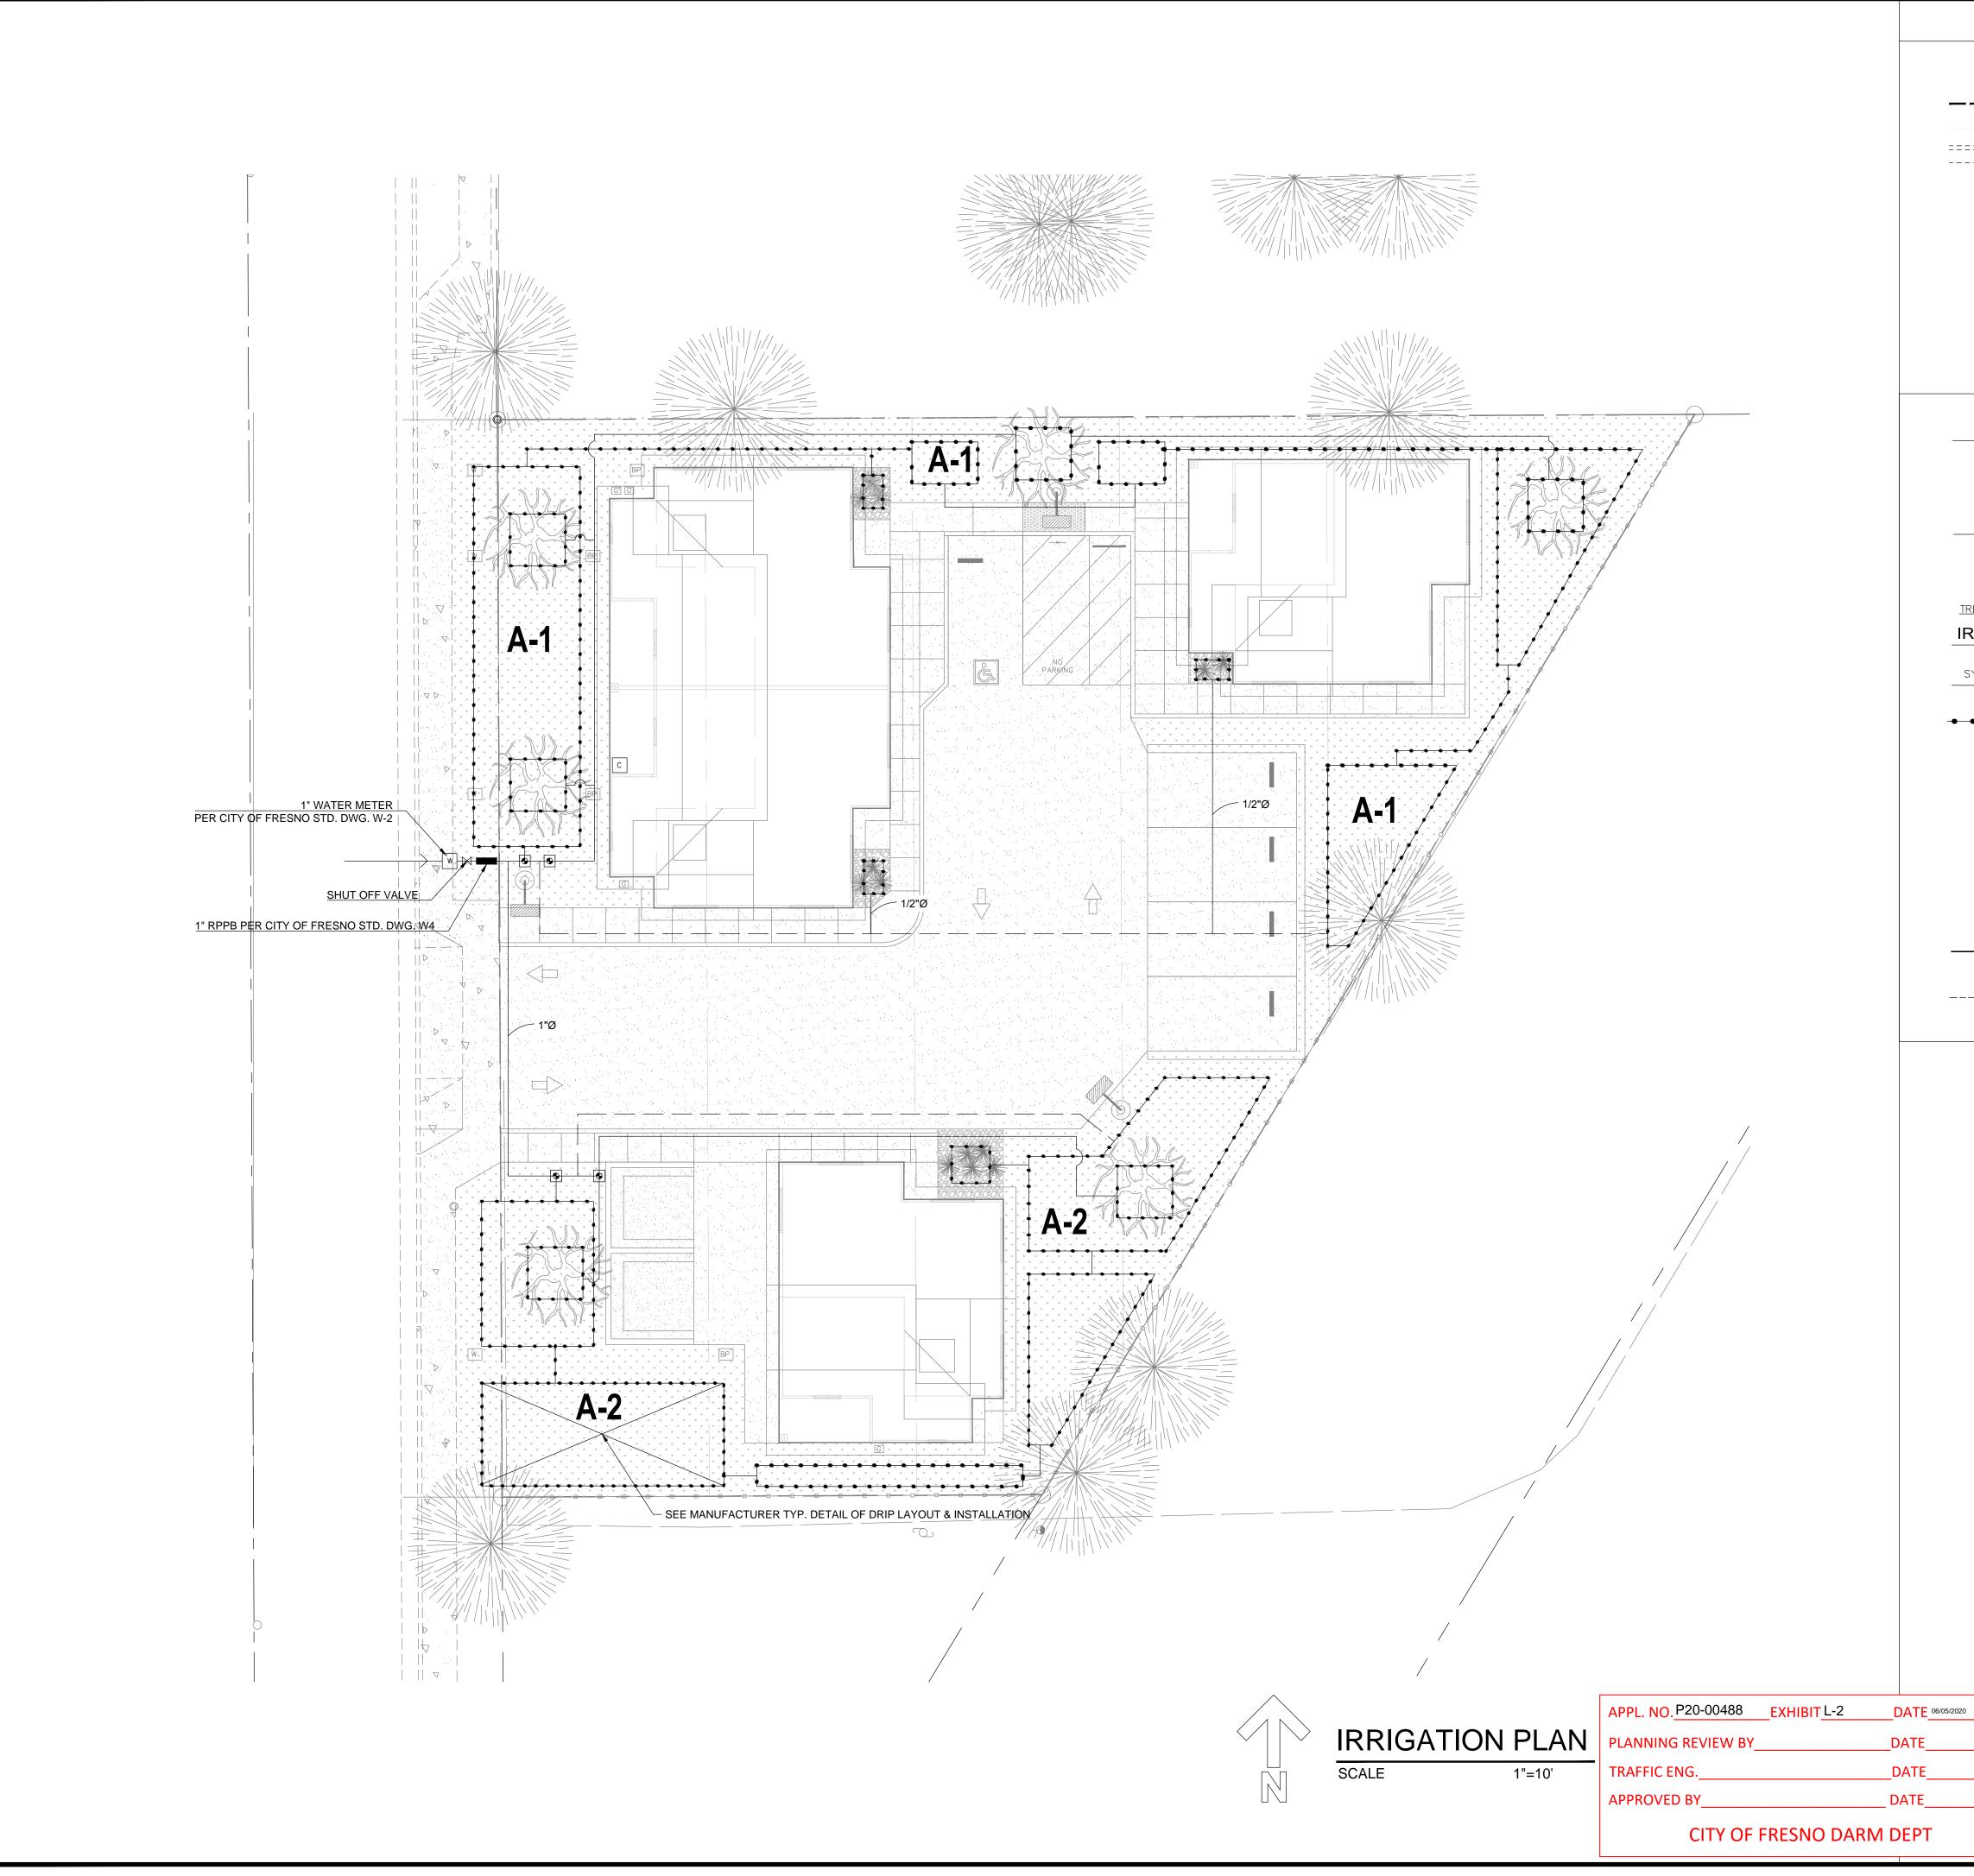

LANDSCAPE LEGEND

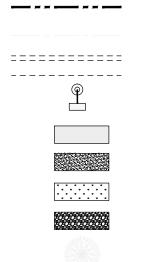

LOT LINES EXISTING CURB AND GUTTER SITE LIGHT ASPHALT PAVING CONCRETE ZOYSIA GRASS REDWOOD BARK MULCH

PROPERTY & RIGHT OF WAY

EXISTING TREE TO REMAIN (PROTECT IN PLACE)

DLS) ER
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UFACTURER)
n Plans)

<u>State of California Model Water Efficiency Landscape</u> Ordinance Calculation (MWELO)

Ordinance	Calculatio		<u>))</u>		
Project: Multi F	amily Residen	tial			
Location: 7236	SN. College Av	ve. Fresno CA			
Water Supply T	ype: Potable				
<u>Site Details</u>					
WUCOLS Plan	t Factor (PF):		0.3 (Low)		
IRRIGATION E	FFICIENCY (I	E):	0.71 (Drip)		
EVAPOTRANS	PIRATION RA	TE (ETo):	51.1 Inches p	ber year	
TOTAL LANDS		(HA):	5,232 SQFT		
Special Landso	ape Area (SLA	\) :	0		
Turf			0		
Zone or Valve	Hydrozone	Irrigation Met	hod Area	% of Landscape Area	
A-1	Low	Drip	2,885	55.14%	
A-2	Low	Drip	2,347	44.86%	
		Total	5,232	100.00%	
Site Summar	<u>'Y:</u>				
Max. Applied \	Nater Allowar	nce (MAWA) :			
51.1 x 0.62 [.7	1 x 5,232]	= 117	,385 gal/year	(MAWA)	
Est. Total Wat	er Use (ETWL)) :			
PF x HA / IE =	3,029				
51.1 x 0.62 [PI	F x HA / IE]	= 70,0	035 gal / year (ETWU)	
_					
Project Comp	<u>oliance:</u>				
MAWA > ET	WU Projec	t is compliant	under allow	ed limit.	
	" ^ _ E				

93726 resno, C/ ne: (559) **roup** C S S 03 Design, Plannin # ste no Street, 360.7143 Fres (559) Щ + Z 4021 Phone U Ζ Ш Σ Ŷ 4 4 <u>к</u> PREPARED FC N N NS 4 No. C 74564 ∖ Exp. <u>12−31−2</u> REVISION(S) PRELIMINARY – PLAN CHECK SET 🗌 PERMIT SET DRAWN BY : AT CHECKED BY : CZ DATE: 3-12-20

SHEET TITLE:

SHEET:

LANDSCAPE PLAN

" I AGREE TO COMPLY WITH THE REQUIREMENTS OF THE WATER EFFICIENT LANDSCAPE ORDINANCE AND SUBMIT A COMPLETE LANDCAPE DOCUMENTATION PACKAGE."

" I HAVE COMPLIED WITH THE CRITERIA OF THE ORDINANCE AND APPLIED THEM FOR THE EFFICIENT USE OF WATER IN THE LANDSCAPE DESIGN PLANS."